### OGDEN POINT LOT LINE REVISION (LOT CONSOLIDATION)

POR. OF GOV. LOT 2, SW 1/4, SW 1/4, SEC. 12, TWP. 24N, RGE 4E, W.M.

### OWNER'S DECLARATION

I, THE UNDERSIGNED, OWNER IN FEE SIMPLE OF THE LAND HEREIN DESCRIBED DO HEREBY MAKE A LOT LINE REVISION (LOT CONSOLIDATION) THEREOF PURSUANT TO RCW 58.09 AND DECLARE THIS LOT LINE REVISION (LOT CONSOLIDATION) TO BE THE GRAPHIC REPRESENTATION OF SAME, AND THAT SAID LOT LINE REVISION (LOT CONSOLIDATION) IS MADE WITH THE FREE CONSENT AND IN ACCORDANCE WITH THE DESIRE OF THE OWNER.

IN WITNESS WHEREOF I HAVE SET	MY HAND AND SEAL.	
MICHAEL E. MORGAN		
PRINTED NAME:		
ACKNOWLEDGE	EMENTS	
STATE OF WASHINGTON ) COUNTY OF KING )		
ON THIS DAY PERSONALLY APPEA SIGNED THIS INSTRUMENT AND AC ACT FOR THE USES AND PURPOS GIVEN UNDER MY HAND AND OFFI	KOWLEDGED IT TO BE HIS F ES MENTIONED IN THE INSTR	RUMENT.
GIVEN SINDER WIT TIAND AND SITT	SIGNATURE OF DAT	Or, 2017.
	PRINTED NAME	OR THE STATE OF WASHINGTON,
	RESIDING AT,	
	MY COMMISSION EXPIRES	
APPROVALS		
CITY OF MERCER ISLAN	<b>ID</b>	
EXAMINED AND APPROVED THIS	DAY OF	2017.

\_\_CODE OFFICIAL

\_CITY ENGINEER

### ORIGINAL LEGAL DESCRIPTIONS

### ORIGINAL LOT A

LOT A, MERCER ISLAND SHORT PLAT NUMBER MI-76-8-027, RECORDED UNDER RECORDING NUMBER 7702170577, AND AS AMENDED BY BOUNDARY LINE REVISION PER CITY OF MERCER ISLAND FILE NO. MI-81-08-15 AS RECORDED UNDER RECORDING NUMBER 8211169001, SAID SHORT PLAT BEING A PORTION OF BLOCK A, REPLAT OF ISLAND PARK, ACCORDING TO THE PLAT THEREOF, RECORDED IN VOLUME 13 OF PLATS, PAGE 58, IN KING COUNTY, WASHINGTON;

TOGETHER WITH SECOND CLASS SHORELANDS ADJACENT THERETO;

TOGETHER WITH AN EASEMENT FOR INGRESS AND EGRESS OVER AN EXISTING PRIVATE ROADWAY LOCATED UPON PROPERTY ADJOINING AS CREATED BY EASEMENTS RECORDED UNDER RECORDING NUMBERS 3860939 AND 3927412, AND ALSO AS DELINEATED ON THE FACE OF SAID BOUNDARY LINE REVISION; AND

TOGETHER WITH PARKING INGRESS, EGRESS AND DRAINAGE EASEMENT AS ESTABLISHED BY PARKING AREA EASEMENT RECORDED UNDER RECORDING NUMBER 5094317 AND AS FURTHER DESCRIBED IN DEED RECORDED UNDER RECORDING NUMBER 8308170194: AND

TOGETHER WITH THAT CERTAIN EASEMENT FOR UNDERGROUND AND OVERHEAD UTILITIES AS ESTABLISHED BY UTILITY EASEMENT RECORDED UNDER RECORDING NUMBER 9304061280.

### ORIGINAL LOT B

LOT B, MERCER ISLAND SHORT PLAT NUMBER MI-76-8-027, RECORDED UNDER RECORDING NUMBER 7702170577, AND AS AMENDED BY BOUNDARY LINE REVISION PER CITY OF MERCER ISLAND FILE NO. MI-81-08-15 AS RECORDED UNDER RECORDING NUMBER 8211169001, SAID SHORT PLAT BEING A PORIONT OF BLOCK A. REPLAT OF ISLAND PARK, ACCORDING TO THE PLAT THEREOF, RECORDED IN VOLUME 13 OF PLATS, PAGE 58, IN KING COUNTY, WASHINGTON;

TOGETHER WITH SECOND CLASS SHORELANDS ADJACENT THERETO;

TOGETHER WITH AN EASEMENT FOR INGRESS AND EGRESS OVER AN EXISTING PRIVATE ROADWAY LOCATED UPON PROPERTY ADJOINING AS CREATED BY EASEMENTS RECORDED UNDER RECORDING NUMBERS 3860939 AND 3927412, AND ALSO AS DELINEATED ON THE FACE OF SAID BOUNDARY LINE REVISION; AND

TOGETHER WITH PARKING INGRESS. EGRESS AND DRAINAGE EASEMENT AS ESTABLISHED BY PARKING AREA EASEMENT RECORDED UNDER RECORDING NUMBER 5094317 AND AS FURTHER DESCRIBED IN DEED RECORDED UNDER RECORDING NUMBER 8308170194; AND

TOGETHER WITH THAT CERTAIN EASEMENT FOR UNDERGROUND AND OVERHEAD UTILITIES AS ESTABLISHED BY UTILITY EASEMENT RECORDED UNDER RECORDING NUMBER 9304061280.

### ORIGINAL LOT C


LOT C, MERCER ISLAND SHORT PLAT NUMBER MI-76-8-027, RECORDED UNDER RECORDING NUMBER 7702170577, AND AS AMENDED BY BOUNDARY LINE REVISION PER CITY OF MERCER ISLAND FILE NO. MI-81-08-15 AS RECORDED UNDER RECORDING NUMBER 8211169001, SAID SHORT PLAT BEING A PORIONT OF BLOCK A, REPLAT OF ISLAND PARK, ACCORDING TO THE PLAT THEREOF, RECORDED IN VOLUME 13 OF PLATS, PAGE 58, IN KING COUNTY, WASHINGTON;

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TOGETHER WITH THAT CERTAIN EASEMENT FOR UNDERGROUND AND OVERHEAD UTILITIES AS ESTABLISHED BY UTILITY EASEMENT RECORDED UNDER RECORDING NUMBER 9304061280.



<u>VICINITY MAP</u> NOT TO SCALE

### LEGAL DESCRIPTIONS AFTER CONSOLIDATION
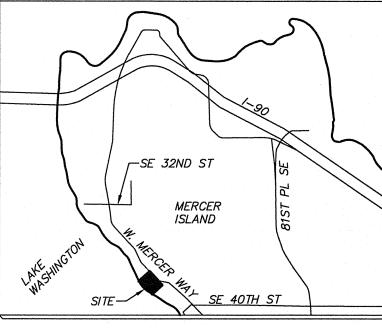
### LOT 1

LOTS A AND B, MERCER ISLAND SHORT PLAT NUMBER MI-76-8-027, RECORDED UNDER RECORDING NUMBER 7702170577, AND AS AMENDED BY BOUNDARY LINE REVISION PER CITY OF MERCER ISLAND FILE NO. MI-81-08-15 AS RECORDED UNDER RECORDING NUMBER 8211169001, SAID SHORT PLAT BEING A PORIONT OF BLOCK A, REPLAT OF ISLAND PARK, ACCORDING TO THE PLAT THEREOF, RECORDED IN VOLUME 13 OF PLATS, PAGE 58, IN KING COUNTY, WASHINGTON;

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TOGETHER WITH THAT CERTAIN EASEMENT FOR UNDERGROUND AND OVERHEAD UTILITIES AS ESTABLISHED BY UTILITY EASEMENT RECORDED UNDER RECORDING NUMBER 9304061280.

### LOT 2

LOT C, MERCER ISLAND SHORT PLAT NUMBER MI-76-8-027, RECORDED UNDER RECORDING NUMBER 7702170577, AND AS AMENDED BY BOUNDARY LINE REVISION PER CITY OF MERCER ISLAND FILE NO. MI-81-08-15 AS RECORDED UNDER RECORDING NUMBER 8211169001, SAID SHORT PLAT BEING A PORIONT OF BLOCK A, REPLAT OF ISLAND PARK, ACCORDING TO THE PLAT THEREOF, RECORDED IN VOLUME 13 OF PLATS, PAGE 58, IN KING COUNTY, WASHINGTON:

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TOGETHER WITH THAT CERTAIN EASEMENT FOR UNDERGROUND AND OVERHEAD UTILITIES AS ESTABLISHED BY UTILITY EASEMENT RECORDED UNDER RECORDING NUMBER 9304061280.

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MERCER ISLAND FILE NO. SWB 17-004

POR. OF GOV. LOT 2, (SW1/4, SW 1/4), SEC. 12, TWP. 24N, RGE 4E, W.M. & LOT A & B, MISP 81-08-15, REC. NO. 8211169001 MERCER ISLAND, WASHINGTON

### RECORDING CERTIFICATE

EXAMINED AND APPROVED THIS \_\_\_\_\_ DAY OF\_\_\_\_

KING COUNTY DEPARTMENT OF ASSESSMENTS

EXAMINED AND APPROVED THIS \_\_\_\_\_ DAY OF\_\_\_\_\_\_ 2017.

Filed for record this\_\_\_\_day of\_\_\_ 2017\_\_\_\_at\_\_\_\_M., in book\_\_ SURVEYS at page\_\_\_\_ \_\_\_\_at the request of TRIAD, A DIVISION OF DAVID EVANS AND ASSOCIATES, INC. DIVISION OF RECORDS & ELECTIONS

Supt. of Records REC. NO.

**ASSESSOR** 

Manager


### SURVEYOR'S CERTIFICATE

This map correctly represents a survey made by me or under my direction in conformance with the requirements of the SURVEY RECORDING ACT at the request of

THE LADYBUG TRUST

*AUGUST* 

\_cert. no. 36805

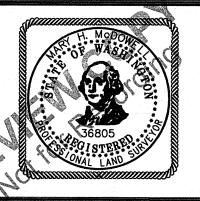

LOT LINE REVISION (LOT CONSOLIDATION)

OGDEN POINT

3675 W. MERCER WAY

MERCER ISLAND

WASHINGTON

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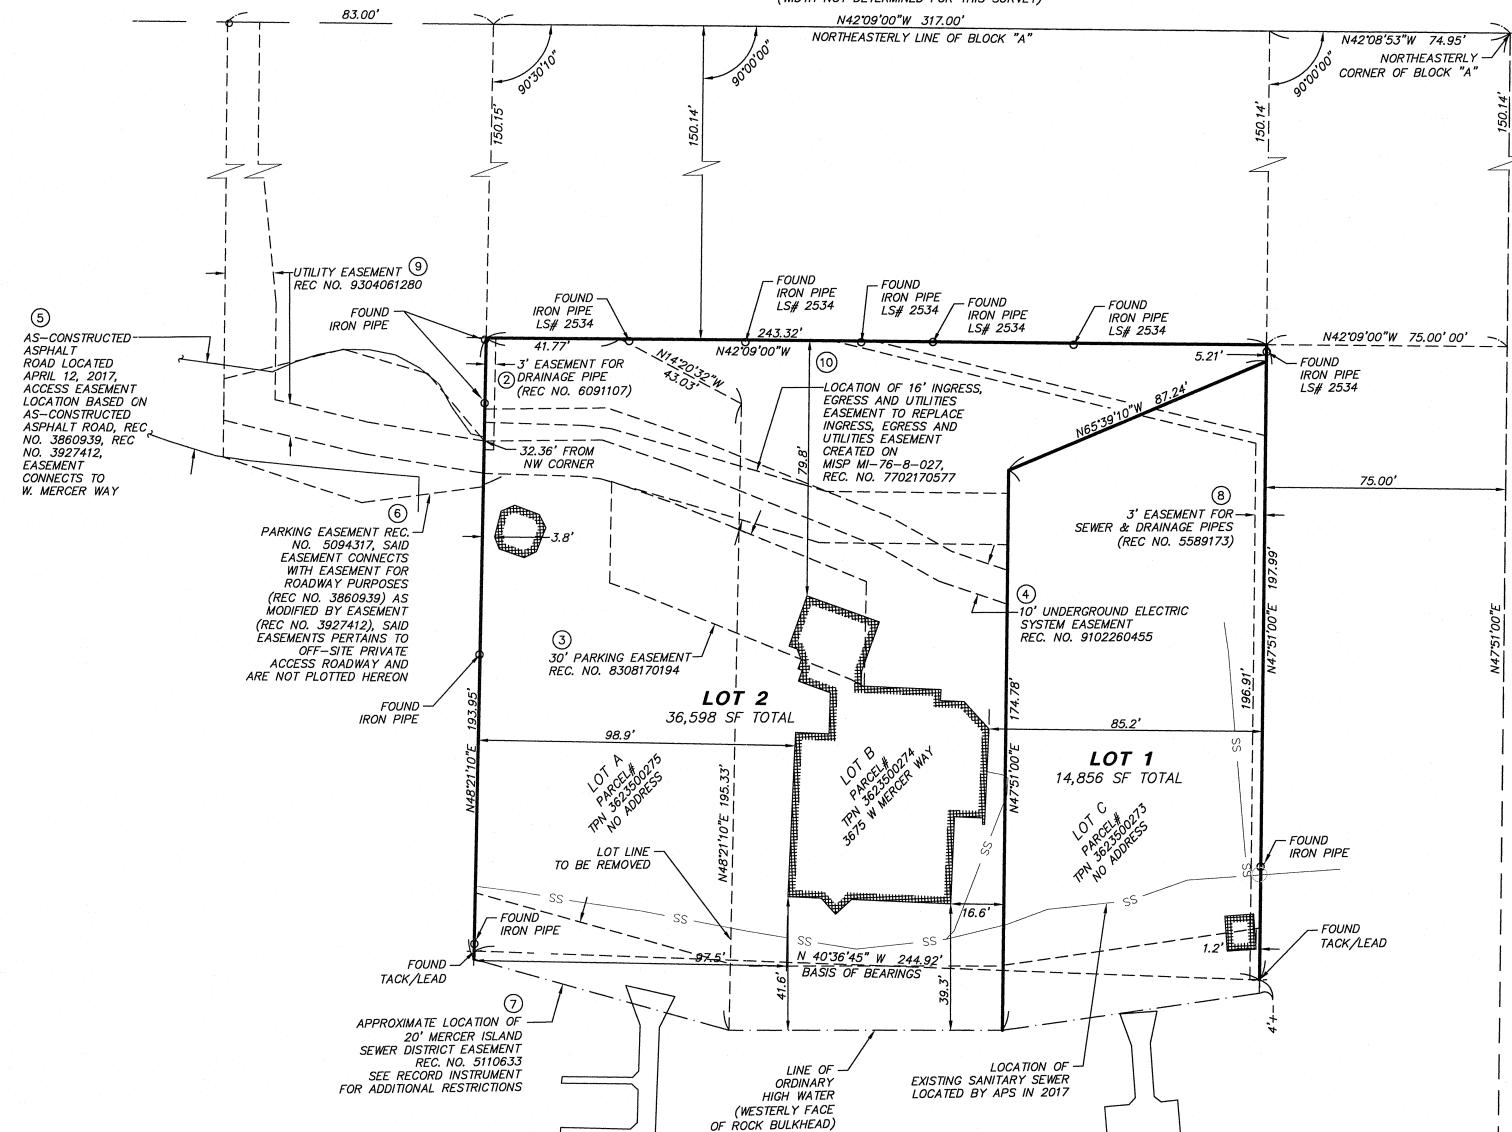
Date 10/25/2017 LDYB00000001 Drawn\_LMM Sheet Checked\_MHM 1 OF 4


# OGDEN POINT LOT LINE REVISION (LOT CONSOLIDATION)

POR. OF GOV. LOT 2, SW 1/4, SW 1/4, SEC. 12, TWP. 24N, RGE 4E, W.M.

### WEST MERCER WAY

(WIDTH NOT DETERMINED FOR THIS SURVEY)



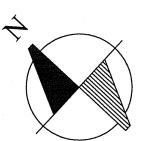

### SCALE: 1" = 30'

0 15 30

### BASIS OF BEARING

HELD BEARING OF NORTH 40°36'45" WEST BETWEEN EXISTING TACKS SET IN LEAD BY H.W. RUTHERFORD IN 1959, AS SHOWN HEREON AND REFERENCED.

### HORIZONTAL DATUM

ASSUMED

VERTICAL DATUM

NAVD88

### BENCH MARK

ORIGINAL BENCHMARK:

ORIGINAL BENCHMARK:

WGS SURVEY DATA WAREHOUSE POINT DESIGNATION—8037,, 2" BRASS

CAP IN 4" CONC. MON (DN 0.3') WEST MERCER WAY AT JOG100' SE

OF INTERSECTION OF LAKE PL. 950' NW OF INTERSECTION SE 40TH ST.

ELEV 171.06'

SET TACK ON CENTERLINE OF DOCK ON LOT A  $\pm 10$  FROM SHORE. ELEVATION = 17.48'

### GENERAL NOTES

- 1. INSTRUMENTATION FOR THIS SURVEY WAS A TRIMBLE ELECTRONIC DISTANCE MEASURE UNIT. PROCEDURES USED IN THIS SURVEY WERE FIELD TRAVERSE, MEETING OR EXCEEDING STANDARDS SET BY WAC 332-130-090.
- 2. THE ON—SITE INFORMATION DEPICTED ON THIS MAP IS BASED ON REPRESENTS THE RESULTS OF A FIELD SURVEY MADE BY TERRANE IN JULY 2016 AND CAN ONLY BE CONSIDERED AS INDICATING THE GENERAL CONDITION EXISTING AT THAT TIME.
- 3. EASEMENTS SHOWN ON THIS SHEET ARE BASED ON CHICAGO TITLE INSURANCE COMPANY, 3RD REVISION, SUBDIVISION GUARANTEE NO. 0091236-06, DATED JULY 13, 2017 @ 8:00 AM. AND ARE THE EXISTING EASEMENTS AS AFFECTING THE ORIGINAL SHORT PLAT MISP MI-76-9-027 UPON ITS RECORDING IN 1977.

### EASEMENTS TO BE RELINGUISHED BY SEPARATE DOCUMENT

- 2 3' EASEMENT FOR DRAINAGE PIPE, RECORDING NO. 6091107
- 3 30' PARKING EASEMENT, RECORDING NO. 8308170194
- (4) 10' UNDERGROUND ELECTRIC SYSTEM EASEMENT, RECORDING NO. 9102260455

  ALL RECORDS OF KING COUNTY, WASHINGTON

### EASEMENTS TO REMAIN IN EFFECT

- (5) ACCESS EASEMENTS, RECORDING NOS. 3860939 AND 3927412
- 6 PARKING EASEMENT, RECORDING NO. 5094317
- 7) 20' SEWER EASEMENT, RECORDING NO. 5110633
- (8) 3' EASEMENT FOR SEWER & DRAINAGE PIPES, RECORDING NO. 5589173
- (9) UTILITY EASEMENT, RECORDING NO. 9304061280
- NEW LOCATION OF 16-FOOT INGRESS/EGRESS AND UTILITY EASEMENT,
  TO REPLACE EXTINGUISHED ONE, ALL PER THIS SHORT PLAT ALTERATION.
  THIS EASEMENT PROVIDES ACCESS TO EXISTING LOT C.
  ALL RECORDS OF KING COUNTY, WASHINGTON

# REVIEW COPY Not for Recording

POR. OF GOV. LOT 2, (SW1/4, SW 1/4), SEC. 12, TWP. 24N, RGE 4E, W.M. & LOT A & B, MISP 81-08-15, REC. NO. 8211169001. MERCER ISLAND, WASHINGTON



MERCER ISLAND FILE NO. SWB 17-004

### OGDEN POINT

3675 W. MERCER WAY

WASHINGTON



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LOT LINE REVISION

(LOT CONSOLIDATION)

WITH EXISTING CONDITIONS

MERCER ISLAND


WASH


# OGDEN POINT LOT LINE REVISION (LOT CONSOLIDATION)

POR. OF GOV. LOT 2, SW 1/4, SW 1/4, SEC. 12, TWP. 24N, RGE 4E, W.M.

### WEST MERCER WAY

(WIDTH NOT DETERMINED FOR THIS SURVEY)

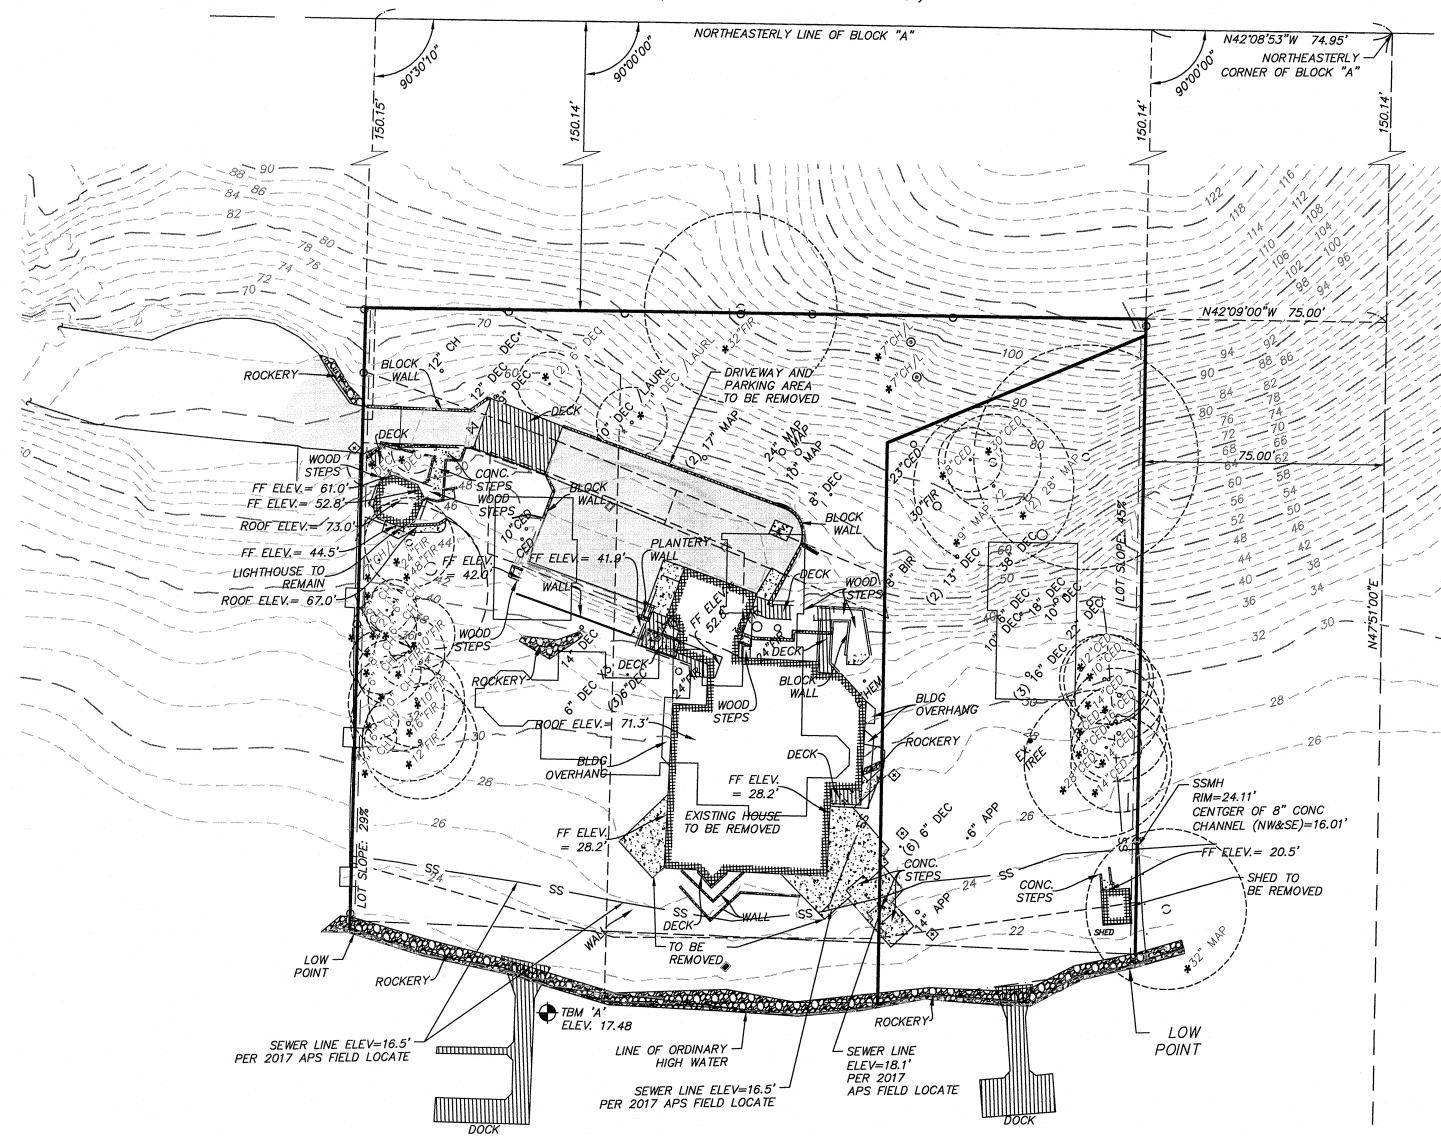

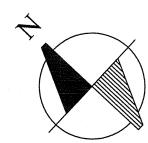

SCALE: 1" = 30'

15 30 6

CONTOUR INTERVAL 2'

BASIS OF BEARING

HELD BEARING OF NORTH 40°36'45" WEST BETWEEN EXISTING TACKS SET IN LEAD BY H.W. RUTHERFORD IN 1959, AS SHOWN HEREON AND REFERENCED.

HORIZONTAL DATUM

ASSUMED

<u>VERTICAL DATUM</u> NAVD88

1011200

BENCH MARK

ORIGINAL BENCHMARK:
WGS SURVEY DATA WAREHOUSE POINT DESIGNATION—8037,,
2" BRASS CAP IN 4" CONC. MON (DN 0.3') WEST MERCER
WAY AT JOG100' SE OF INTERSECTION OF LAKE PL. 950'
NW OF INTERSECTION SE 40TH ST.
ELEV 171.06'

BM "A":

SET TACK ON CENTERLINE OF DOCK ON LOT A  $\pm 10$  FROM SHORE. ELEVATION = 17.48'

### **GENERAL NOTES**

- 1. INSTRUMENTATION FOR THIS SURVEY WAS A TRIMBLE ELECTRONIC DISTANCE MEASURE UNIT. PROCEDURES USED IN THIS SURVEY WERE FIELD TRAVERSE, MEETING OR EXCEEDING STANDARDS SET BY WAC 332-130-090.
- 2. THE ON-SITE INFORMATION DEPICTED ON THIS MAP IS BASED ON REPRESENTS THE RESULTS OF A FIELD SURVEY MADE BY TERRANE IN JULY 2016 AND CAN ONLY BE CONSIDERED AS INDICATING THE GENERAL CONDITION EXISTING AT THAT TIME.
- 3. EASEMENTS SHOWN ON THIS SHEET ARE BASED ON CHICAGO TITLE INSURANCE COMPANY, 3RD REVISION, SUBDIVISION GUARANTEE NO. 0091236-06, DATED JULY 13, 2017 @ 8:00 AM. AND ARE THE EXISTING EASEMENTS AS AFFECTING THE ORIGINAL SHORT PLAT MISP MI-76-9-027 UPON ITS RECORDING IN 1977.
- 4. THE METHODOLOGY USED TO GENERATE THE OFF-SITE CONTOURS WAS BASED ON THE ACCURACY STANDARDS FOR A 5 FOOT CONTOUR SURVEY. THESE CONTOURS WERE INTERPOLATED FROM PUBLIC DOMAIN AIRBORNE LIDAR DATA ACQUIRED IN 2003 BY THE PUGET SOUND LIDAR CONSORTIUM (PSLC). THE ADDITIONAL CONTOURS ARE SHOWN FOR THE CONVENIENCE OF OUR CLIENT AND ARE NOT TO BE CONSTRUED AS HAVING AN ACCURACY GREATER THAN A FIVE FOOT INTERVAL.

<u>LEGEND</u>

\* TREE TO REMAIN

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### **EXISTING CONDITIONS**

### EXISTING LOT AREA

PARCEL A - TPN 3623500275 15,990± SQ. FT. (TO LINE OF ORDINARY HIGH WATER)

PARCEL B -- TPN 3623500274
20,302± SQ. FT. (TO LINE OF ORDINARY HIGH WATER)

PARCEL C -- TPN 3623500273

14,856± SQ. FT. (TO LINE OF ORDINARY HIGH WATER)

### EXISTING GROSS FLOOR AREA

PARCEL A - TPN 3623500275 & B - TPN 3623500274 4,269± SQ. FT.

+,209± 3Q. 11.

PARCEL C - TPN 3623500273 98± SQ. FT. TOTAL 4,367± SQ. FT. EXISTING IMPERVIOUS SURFACE AREA

PARCEL A - TPN 3623500275 & B - TPN 3623500274 10,294± SQ. FT.

PARCEL C - TPN 3623500273 0± SQ. FT.


TOTAL 10,294± SQ. FT.

EXISTING LOT SLOPE

PARCEL A - TPN 3623500275

PARCEL B - TPN 3623500274

PARCEL C - TPN 3623500273

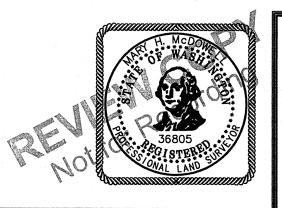

MERCER ISLAND FILE NO. SWB 17-004

LOT LINE REVISION (LOT CONSOLIDATION) FOR

OGDEN POINT

3675 W. MERCER WAY

WASHINGTON

POR. OF GOV. LOT 2, (SW1/4, SW 1/4), SEC. 12, TWP. 24N, RGE 4E, W.M. & LOT A & B, MISP 81-08-15, REC. NO. 8211169001. MERCER ISLAND, WASHINGTON



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 Date\_\_\_10/25/2017
 Job No.

 Drawn\_\_LMM
 LDYB0000001


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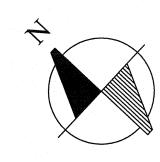
 3 OF 4

MERCER ISLAND

### OGDEN POINT LOT LINE REVISION (LOT CONSOLIDATION)

POR. OF GOV. LOT 2, SW 1/4, SW 1/4, SEC. 12, TWP. 24N, RGE 4E, W.M.



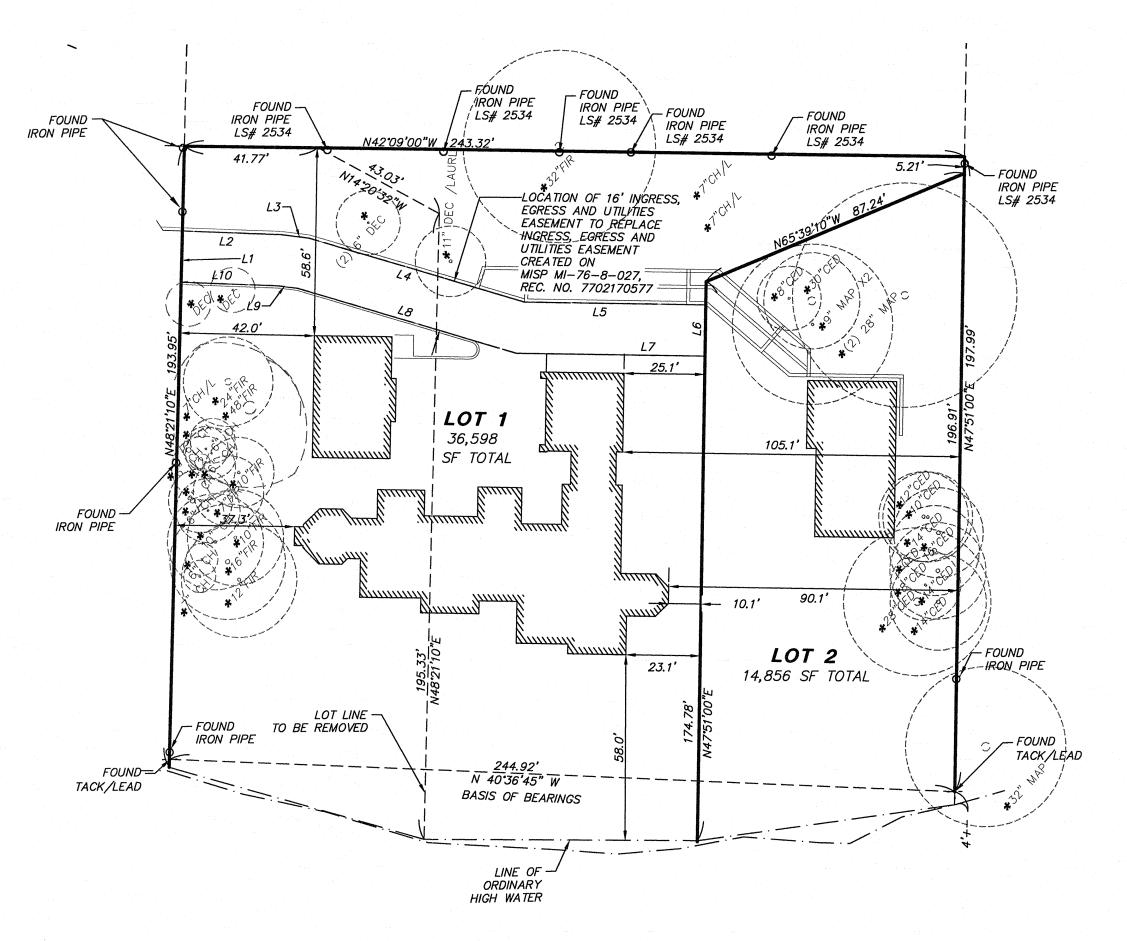

HELD BEARING OF NORTH 40°36'45" WEST BETWEEN EXISTING TACKS SET IN LEAD BY H.W. RUTHERFORD IN 1959, AS SHOWN HEREON AND

HORIZONTAL DATUM

ASSUMED

<u>LEGEND</u>

\* TREE TO REMAIN

LINE TABLE		
LINE	DIRECTION	LENGTH
L1	S48°21'10"W	16.00'
L2	S40*50'08"E	30.93'
L3	S35*45'09"E	8.58'
L4	S26°22'04"E	70.19'
L5	S42°09'00"E	56.57
L6	N47*51'00"E	16.00'
L7	S42°09'00"E	58.78°
L8	S26°22'04"E	71.09'
L9	S35*45'09"E	6.55'
L10	S40°50'08"E	29.99'

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### LOT LINE REVISION (LOT CONSOLIDATION) WITH PROPOSED SITE PLAN

### PROPOSED LOT AREA

LOT 1 - TPN 3623500275 AND TPN 3623500274 36,598± SQ. FT. (TO LINE OF ORDINARY HIGH WATER)

LOT 2 - TPN 3623500273 14,586± SQ. FT. (TO LINE OF ORDINARY HIGH WATER)

### PROPOSED GROSS FLOOR AREA

LOT 1 — TPN 3623500275 AND TPN 3623500274  $11,709\pm$  SQ. FT.

LOT 2 - TPN 3623500273 1,312± TOTAL 13,021

PROPOSED IMPERVIOUS SURFACE AREA

LOT 1 - TPN 3623500275 AND TPN3623500274 10,948 $\pm$  SQ. FT.

PARCEL 2 - TPN 3623500273 4,140± SQ. FT. TOTAL 15,088



MERCER ISLAND FILE NO.

LOT LINE REVISION (LOT CONSOLIDATION) *FOR* 

OGDEN POINT

3675 W. MERCER WAY

& B, MISP 81-08-15, REC. NO. 8211169001. MERCER ISLAND, WASHINGTON

POR. OF GOV. LOT 2, (SW1/4, SW 1/4), SEC. 12, TWP. 24N, RGE 4E, W.M. & LOT A

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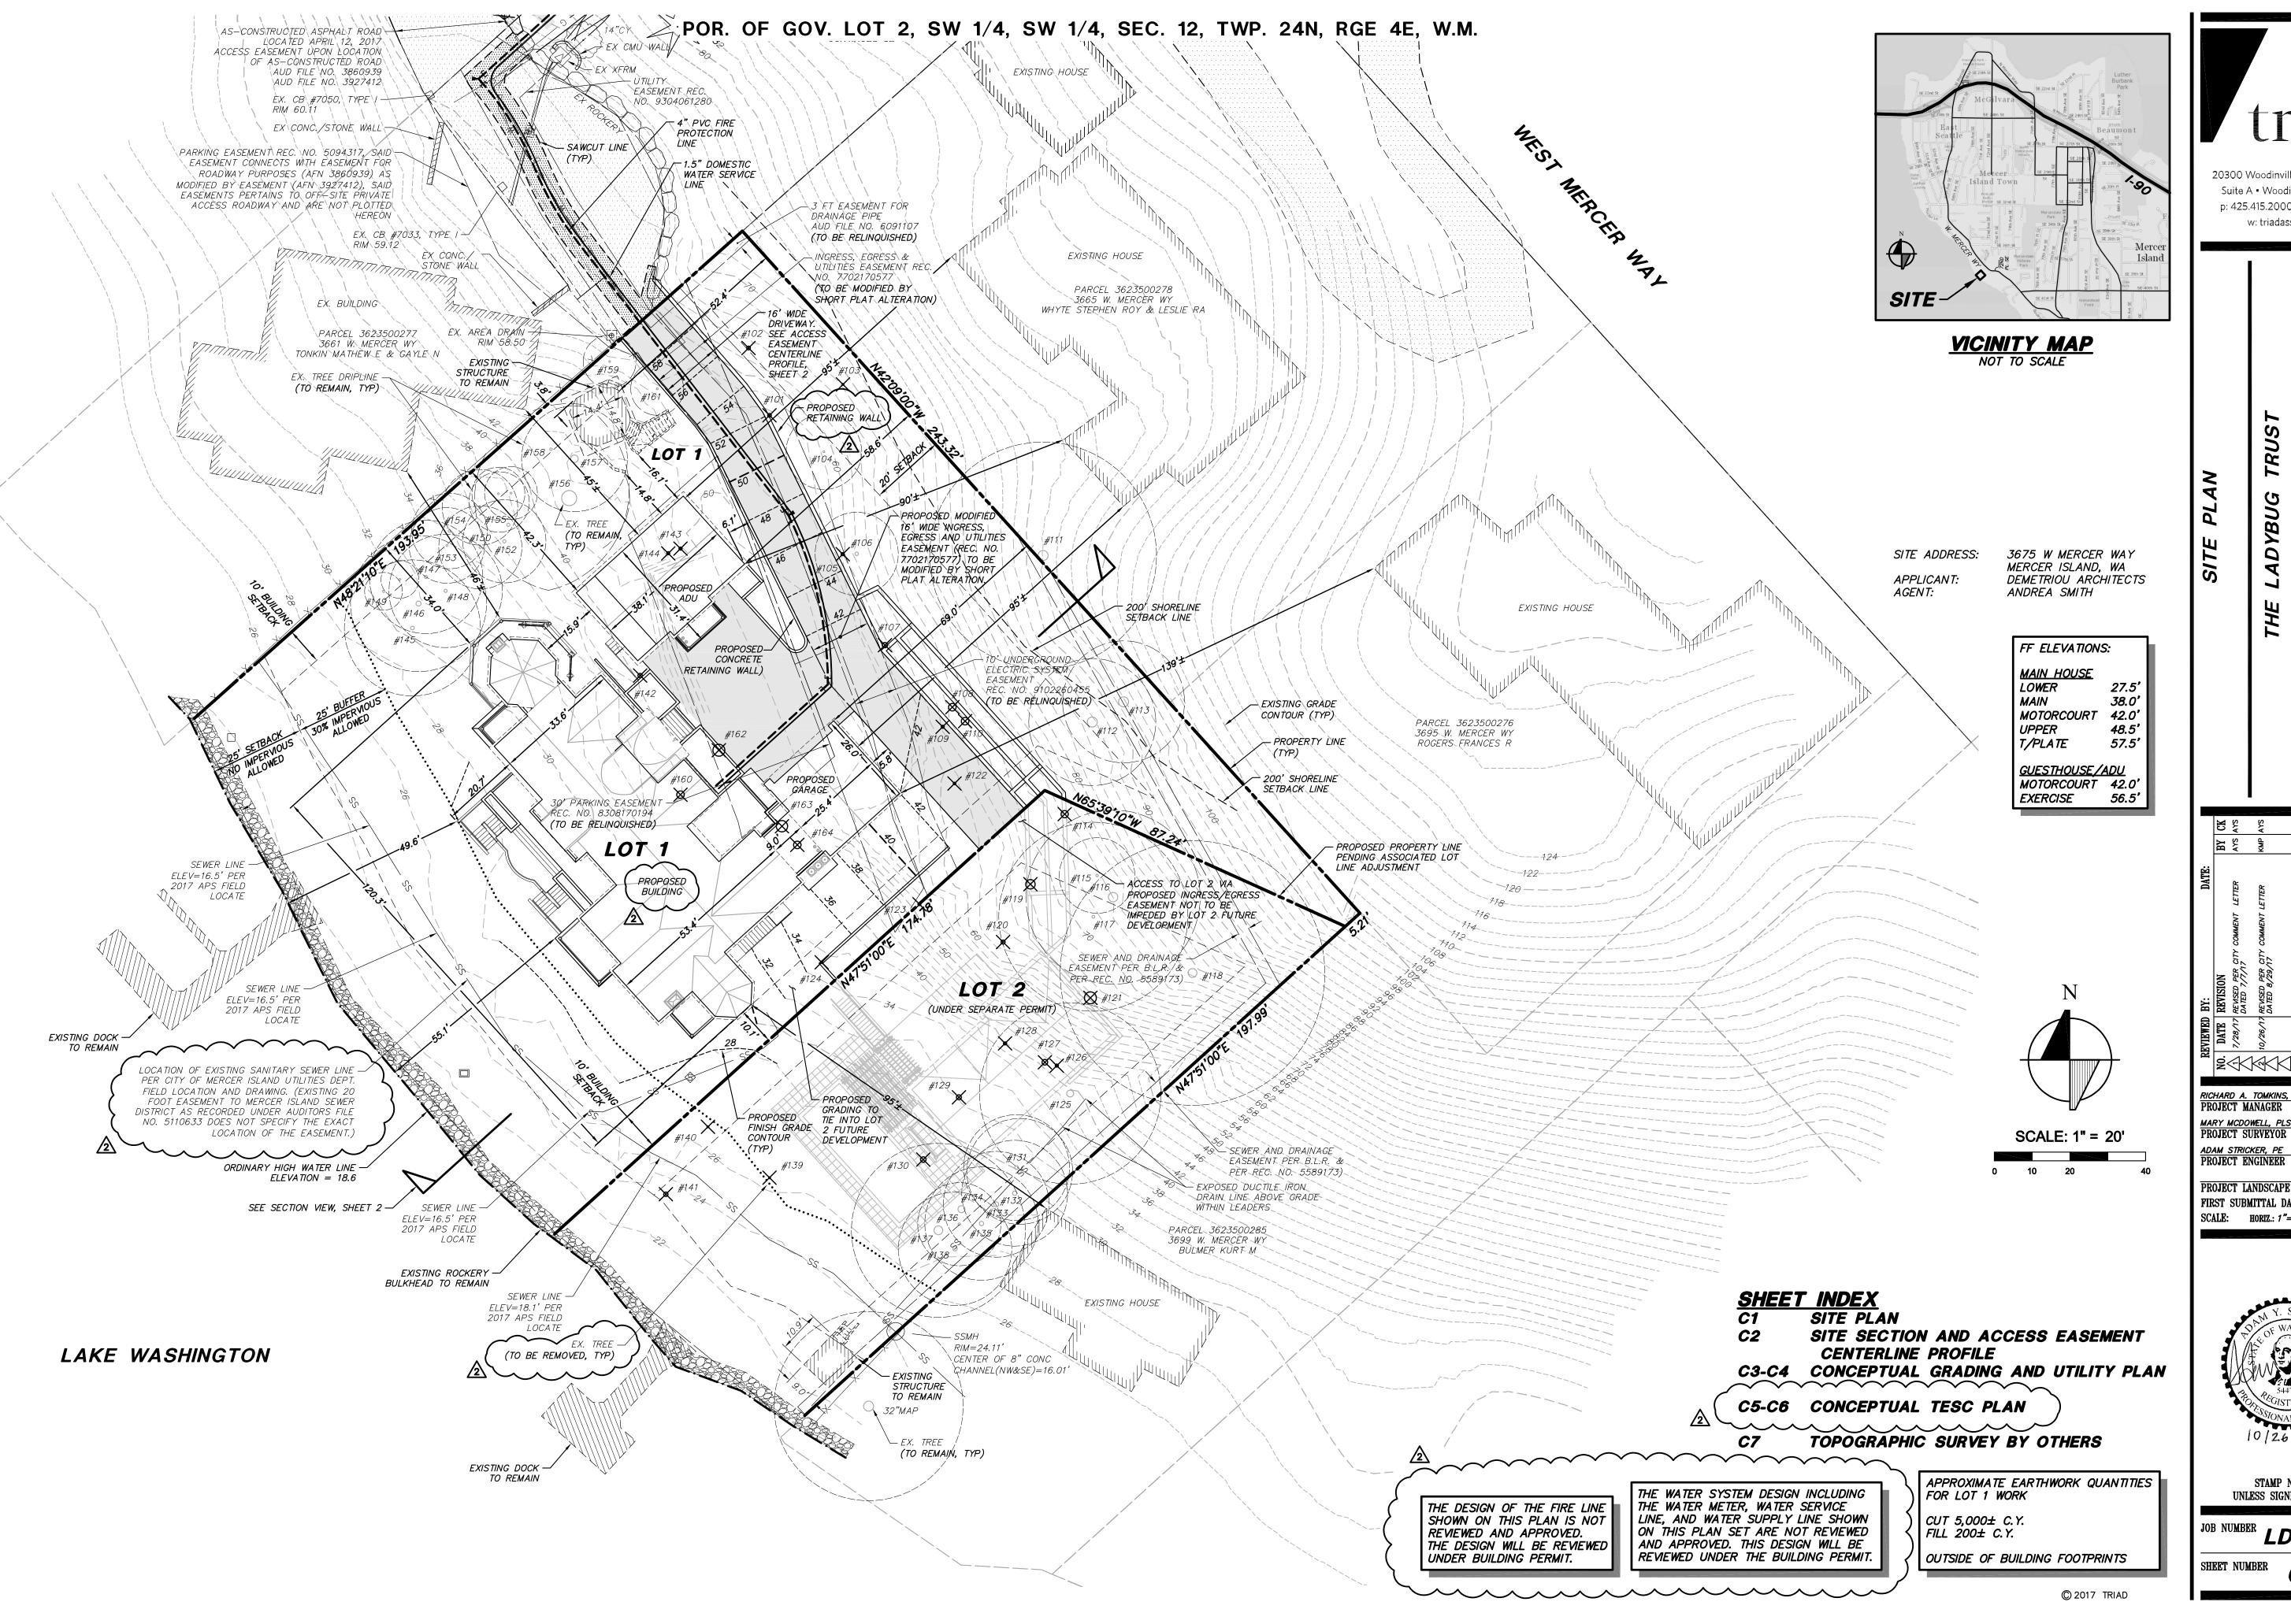
Date\_\_\_10/25/2017 Drawn\_*LMM* 

Checked MHM

Job No. LDYB0000001 Sheet 4 OF 4

MERCER ISLAND

WASHINGTON



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w: triadassociates.net

RICHARD A. TOMKINS, PE PROJECT MANAGER MARY MCDOWELL, PLS PROJECT SURVEYOR

PROJECT LANDSCAPE ARCHITECT FIRST SUBMITTAL DATE: SCALE: HORIZ.: 1"=20' VERT.: N/A



STAMP NOT VALID UNLESS SIGNED AND DATED

JOB NUMBER LDYBOOO2

SHEET NUMBER C10F 7

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RICHARD A. TOMKINS, PE PROJECT MANAGER MARY MCDOWELL, PLS PROJECT SURVEYOR ADAM STRICKER, PE PROJECT ENGINEER


PROJECT LANDSCAPE ARCHITECT FIRST SUBMITTAL DATE: SCALE: HORIZ.: 1"=20' VERT.: AS NOTED



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JOB NUMBER LDYBOOO2

SHEET NUMBER C2 OF 7

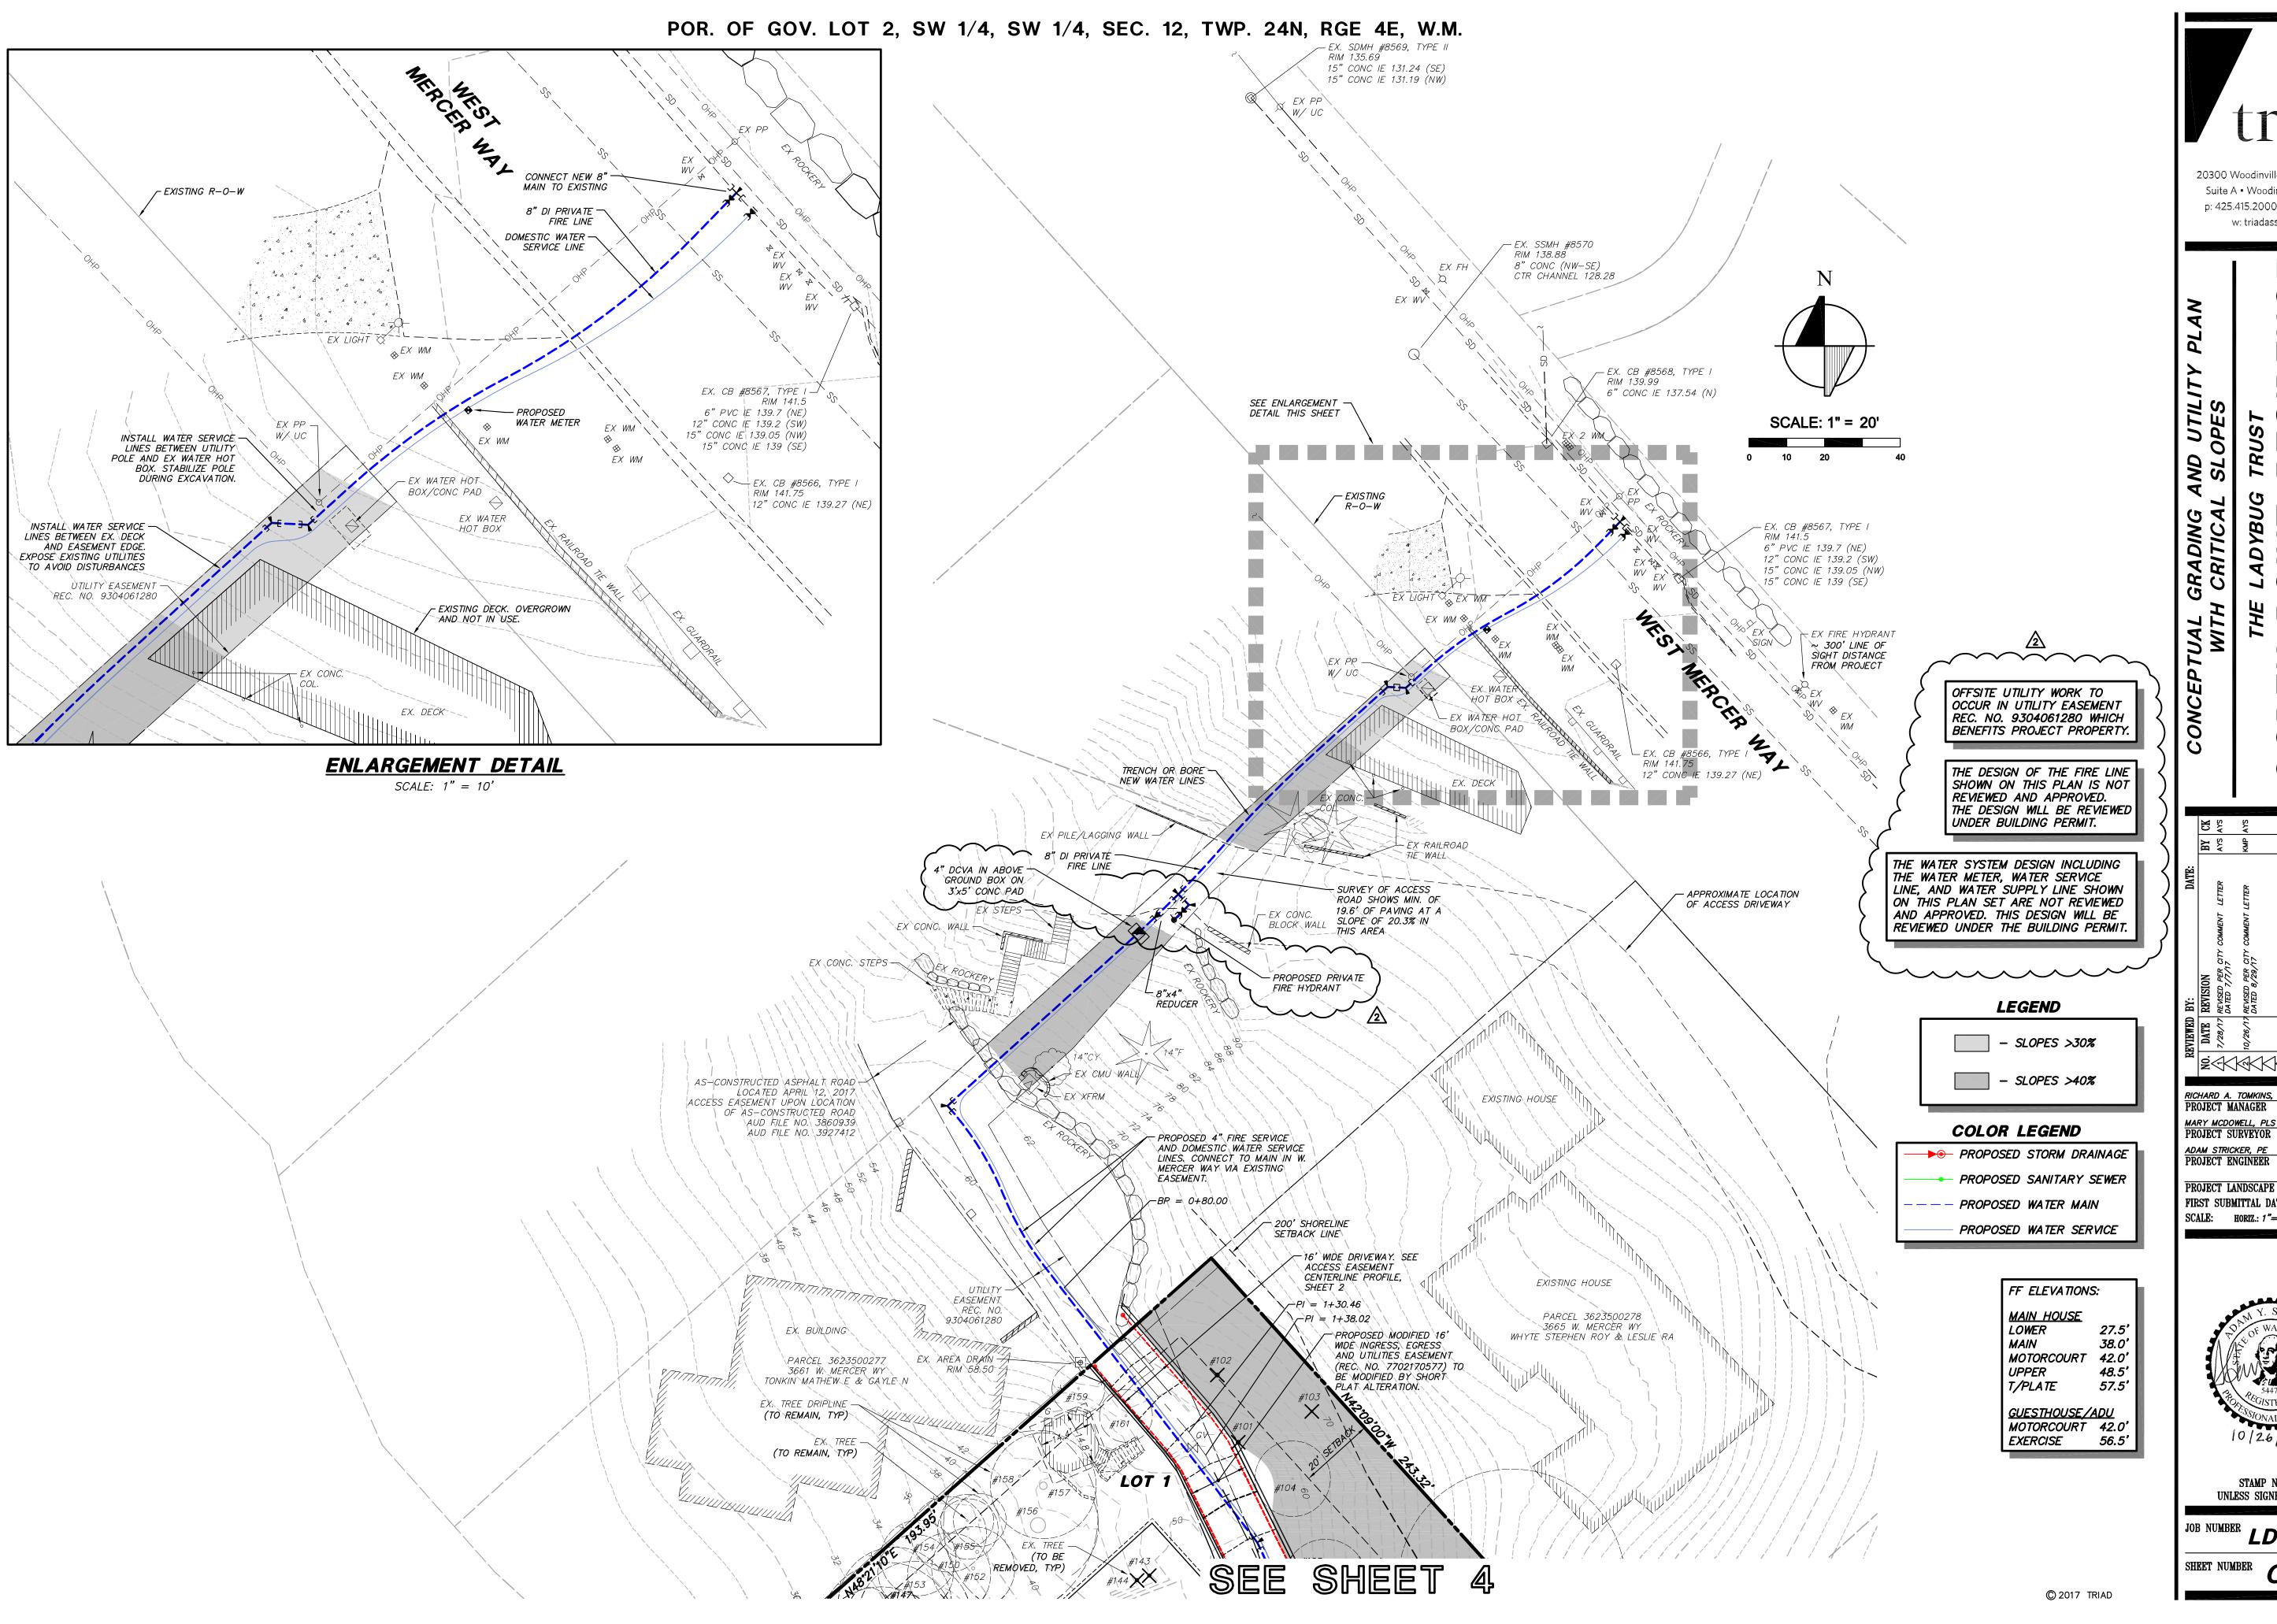


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p: 425.415.2000 f: 425.486.5059 w: triadassociates.net

BY:
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DATED

RICHARD A. TOMKINS, PE PROJECT MANAGER MARY MCDOWELL, PLS PROJECT SURVEYOR


PROJECT LANDSCAPE ARCHITECT FIRST SUBMITTAL DATE: SCALE: HORIZ.: 1"=20' VERT.: N/A

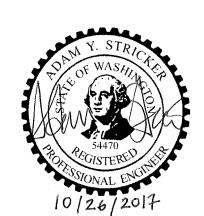

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JOB NUMBER LDYBOOO2

SHEET NUMBER C3 of 7

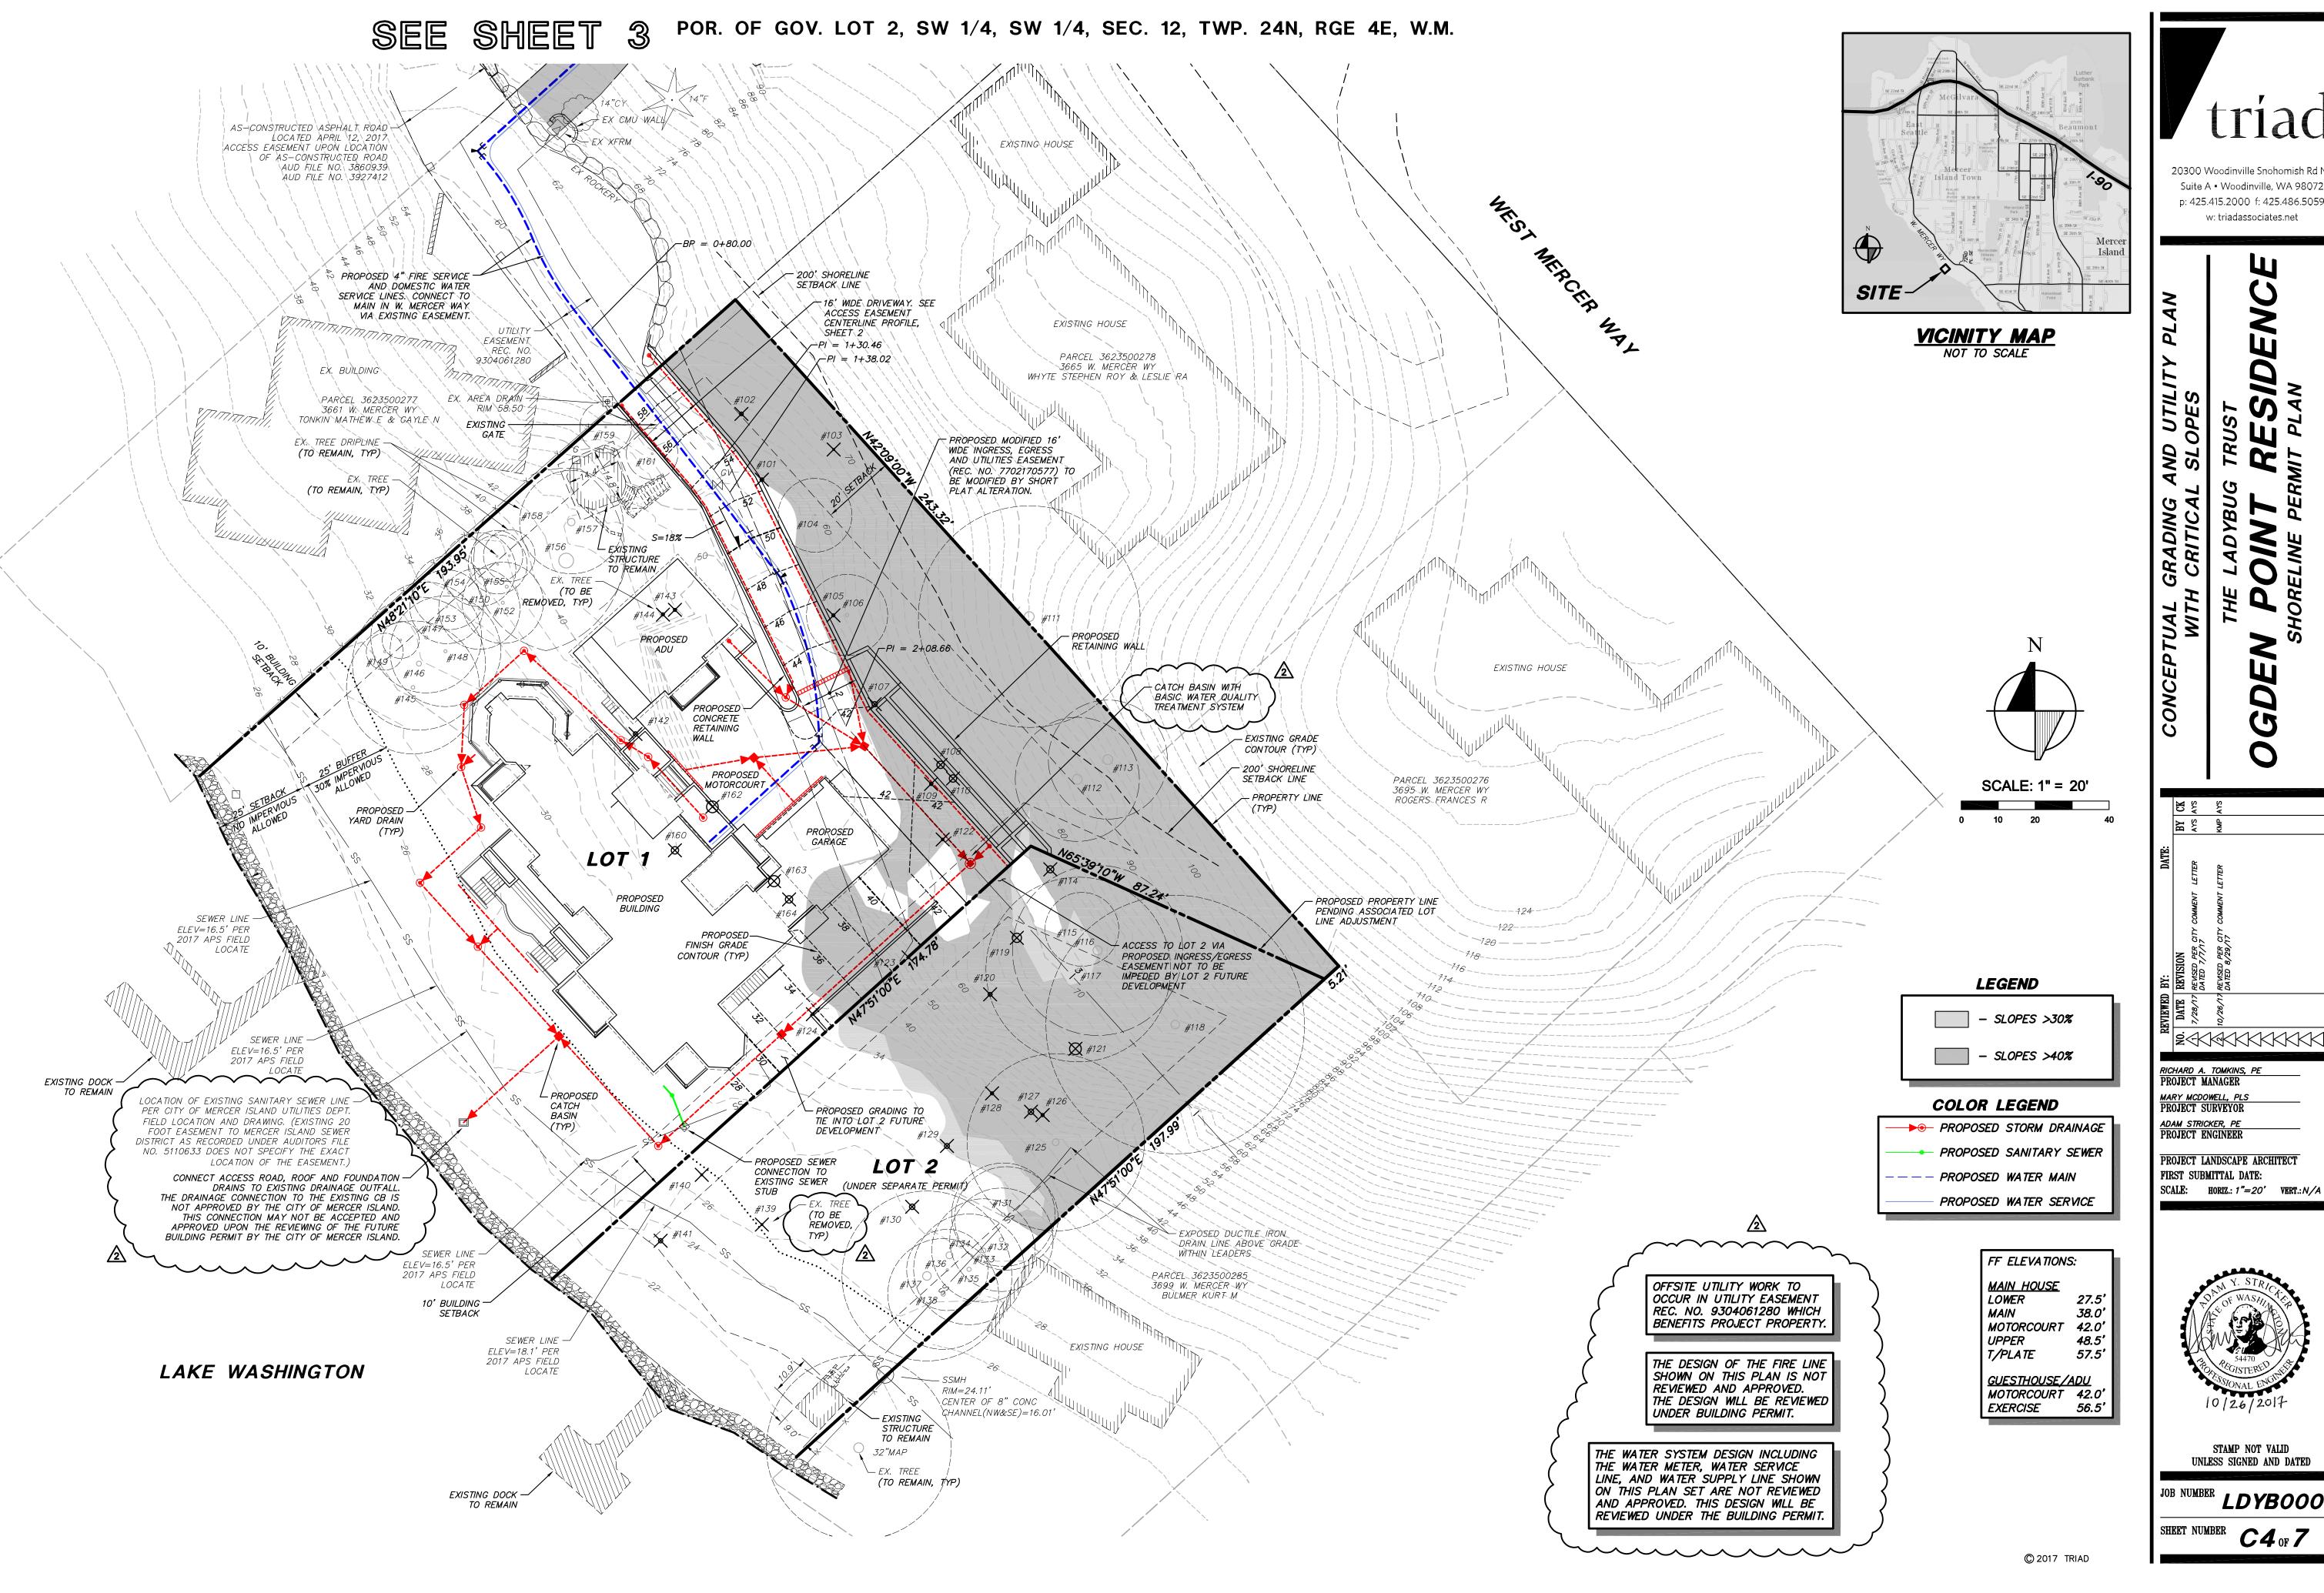

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BY:
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REVISE
DATED
REVISE
REVISE
DATED


RICHARD A. TOMKINS, PE PROJECT MANAGER

MARY MCDOWELL, PLS PROJECT SURVEYOR ADAM STRICKER, PE PROJECT ENGINEER PROJECT LANDSCAPE ARCHITECT

STAMP NOT VALID UNLESS SIGNED AND DATED

JOB NUMBER LDYBOOO2

C4 of 7

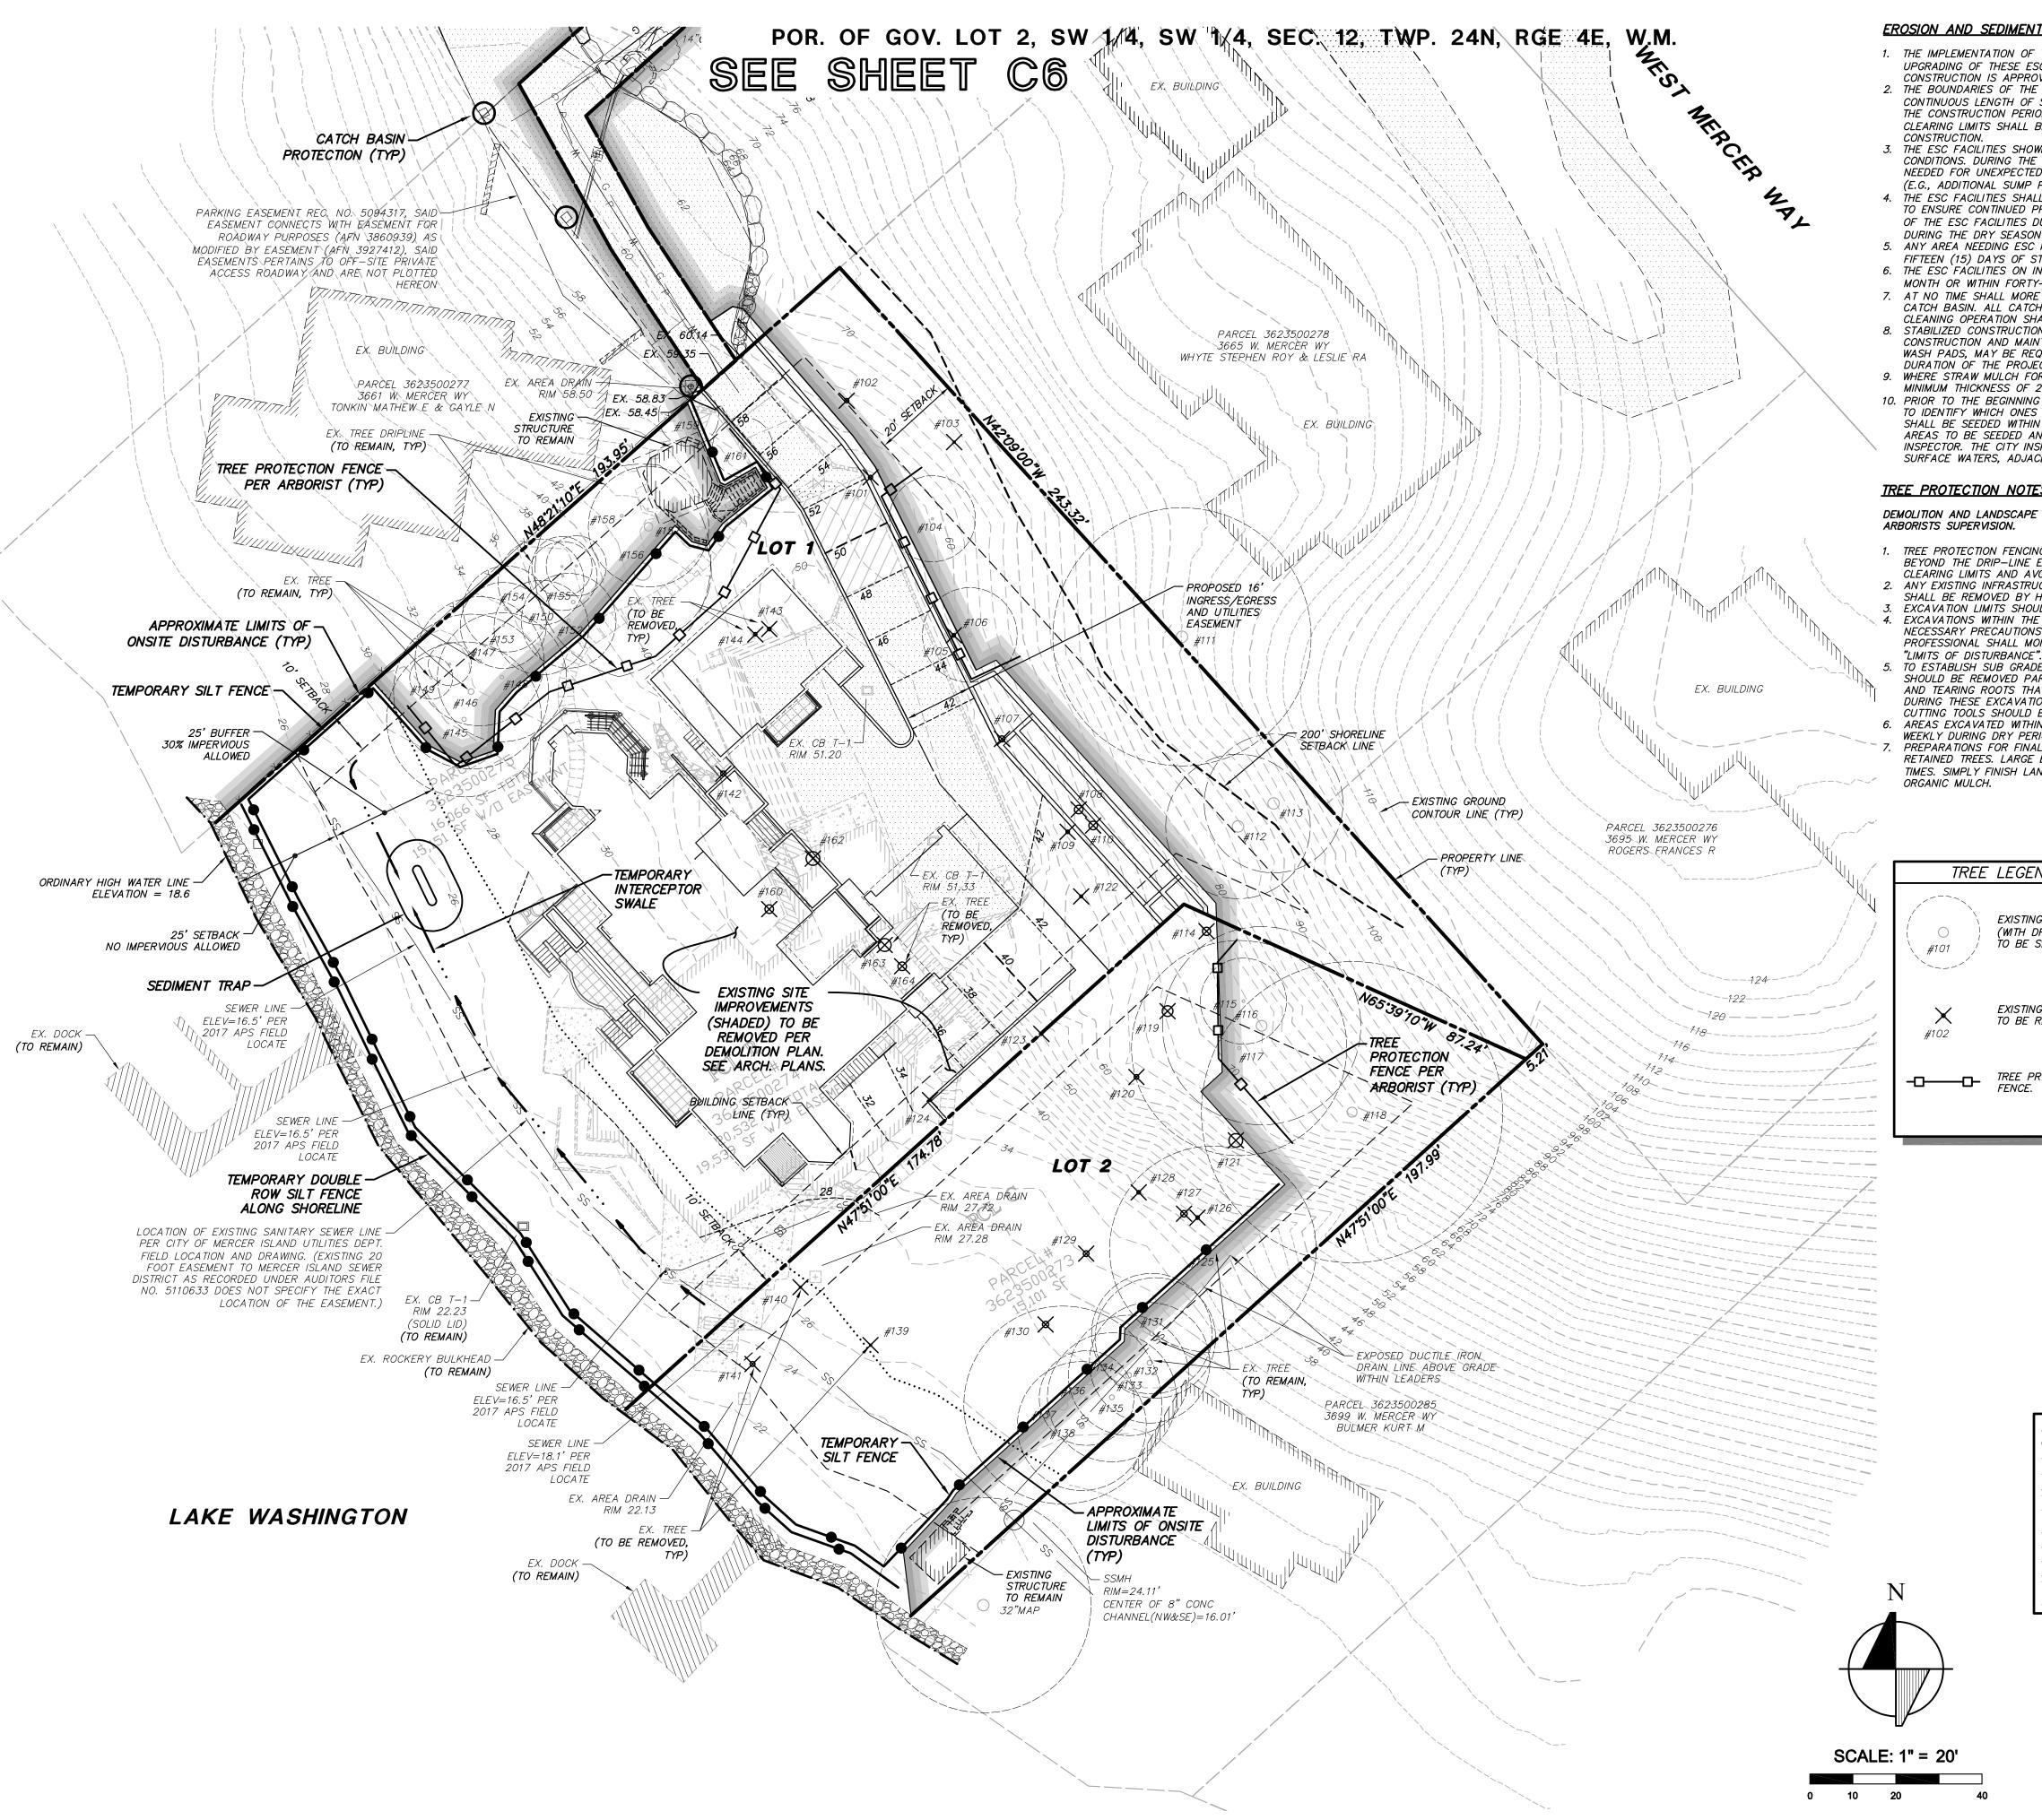

EROSION AND SEDIMENT CONTROL NOTES

1. THE IMPLEMENTATION OF THESE ESC PLANS AND THE CONSTRUCTION, MAINTENANCE, REPLACEMENT, AND UPGRADING OF THESE ESC FACILITIES IS THE RESPONSIBILITY OF THE APPLICANT/CESCL UNTIL ALL CONSTRUCTION IS APPROVED.

2. THE BOUNDARIES OF THE CLEARING LIMITS SHOWN ON THIS PLAN SHALL BE CLEARLY FLAGGED BY A CONTINUOUS LENGTH OF SURVEY TAPE (OR FENCING, IF REQUIRED) PRIOR TO CONSTRUCTION. DURING THE CONSTRUCTION PERIOD, NO DISTURBANCE BEYOND THE CLEARING LIMITS SHALL BE PERMITTED. THE CLEARING LIMITS SHALL BE MAINTAINED BY THE APPLICANT/CESCL FOR THE DURATION OF

3. THE ESC FACILITIES SHOWN ON THIS PLAN ARE THE MINIMUM REQUIREMENTS FOR ANTICIPATED SITE CONDITIONS. DURING THE CONSTRUCTION PERIOD, THESE ESC FACILITIES SHALL BE UPGRADED AS NEEDED FOR UNEXPECTED STORM EVENTS AND MODIFIED TO ACCOUNT FOR CHANGING SITE CONDITIONS (E.G., ADDITIONAL SUMP PUMPS, RELOCATION OF DITCHES AND SILT FENCES, ETC.).

4. THE ESC FACILITIES SHALL BE INSPECTED DAILY BY THE APPLICANT/ESC SUPERVISOR AND MAINTAINED TO ENSURE CONTINUED PROPER FUNCTIONING. WRITTEN RECORDS SHALL BE KEPT OF WEEKLY REVIEWS OF THE ESC FACILITIES DURING THE WET SEASON (OCT. 1 TO APRIL 30) AND OF MONTHLY REVIEWS

DURING THE DRY SEASON (MAY 1 TO SEPT. 30). 5. ANY AREA NEEDING ESC MEASURES NOT REQUÍRING IMMEDIATE ATTENTION SHALL BE ADDRESSED WITHIN FIFTEEN (15) DAYS OF STORM EVENT.

6. THE ESC FÁCILITIES ON INACTIVE SITES SHALL BE INSPECTED AND MAINTAINED A MINIMUM OF ONCE A

MONTH OR WITHIN FORTY-EIGHT (48) HOURS FOLLOWING A STORM EVENT. 7. AT NO TIME SHALL MORE THAN ONE (1) FOOT OF SEDIMENT BE ALLOWED TO ACCUMULATE WITHIN A CATCH BASIN. ALL CATCH BASINS AND CONVEYANCE LINES SHALL BE CLEANED PRIOR TO PAVING. THE

CLEANING OPERATION SHALL NOT FLUSH SEDIMENT LADEN WATER INTO THE DOWNSTREAM SYSTEM. 8. STABILIZED CONSTRUCTION ENTRANCES AND ROADS SHALL BE INSTALLED AT THE BEGINNING OF CONSTRUCTION AND MAINTAINED FOR THE DURATION OF THE PROJECT. ADDITIONAL MEASURES, SUCH AS WASH PADS, MAY BE REQUIRED TO ENSURE THAT ALL PAVED AREAS ARE KEPT CLEAN FOR THE DURATION OF THE PROJECT.

9. WHERE STRAW MULCH FOR TEMPORARY EROSION CONTROL IS REQUIRED, IT SHALL BE APPLIED AT A MINIMUM THICKNESS OF 2 TO 3 INCHES.

10. PRIOR TO THE BEGINNING OF THE WET SEASON (OCT. 1), ALL DISTURBED AREAS SHALL BE REVIEWED TO IDENTIFY WHICH ONES CAN BE SEEDED IN PREPARATION FOR THE WINTER RAINS. DISTURBED AREAS SHALL BE SEEDED WITHIN ONE WEEK OF THE BEGINNING OF THE WET SEASON. A SKETCH MAP OF THOSE AREAS TO BE SEEDED AND THOSE AREAS TO REMAIN UNCOVERED SHALL BE SUBMITTED TO THE CITY INSPECTOR. THE CITY INSPECTOR CAN REQUIRE SEEDING OF ADDITIONAL AREAS IN ORDER TO PROTECT SURFACE WATERS, ADJACENT PROPERTIES, OR DRAINAGE FACILITIES.

### TREE PROTECTION NOTES

DEMOLITION AND LANDSCAPE WORK WITHIN DRIPLINES OF SAVED TREES TO BE PERFORMED UNDER


1. TREE PROTECTION FENCING SHOULD BE ERECTED AROUND RETAINED TREES AND POSITIONED JUST BEYOND THE DRIP-LINE EDGE PRIOR TO MOVING ANY HEAVY EQUIPMENT ON SITE. DOING THIS WILL SET CLEARING LIMITS AND AVOID COMPACTION OF SOILS WITHIN ROOT ZONES OF RETAINED TREES. 2. ANY EXISTING INFRASTRUCTURE TO BE REMOVED WITHIN THE DRIP-LINE OR TREE PROTECTION ZONE SHALL BE REMOVED BY HAND OR UTILIZING A TRACKED MINI-EXCAVATOR.

3. EXCAVATION LIMITS SHOULD BE LAID OUT IN PAINT ON THE GROUND TO AVOID OVER EXCAVATING. 4. EXCAVATIONS WITHIN THE DRIP—LINES SHALL BE MONITORED BY A QUALIFIED TREE PROFESSIONAL SO NECESSARY PRECAUTIONS CAN BE TAKEN TO DECREASE IMPACTS TO TREE PARTS. A QUALIFIED TREE PROFESSIONAL SHALL MONITOR EXCAVATIONS WHEN WORK IS REQUIRED AND ALLOWED WITHIN THE

5. TO ESTABLISH SUB GRADE FOR FOUNDATIONS, CURBS AND PAVEMENT SECTIONS NEAR THE TREES, SOIL SHOULD BE REMOVED PARALLEL TO THE ROOTS AND NOT AT 90 DEGREE ANGLES TO AVOID BREAKING AND TEARING ROOTS THAT LEAD BACK TO THE TRUNK WITHIN THE DRIP-LINE. ANY ROOTS DAMAGED DURING THESE EXCAVATIONS SHOULD BE EXPOSED TO SOUND TISSUE AND CUT CLEANLY WITH A SAW. CUTTING TOOLS SHOULD BE STERILIZED WITH ALCOHOL.

6. AREAS EXCAVATED WITHIN THE DRIP—LINE OF RETAINED TREES SHOULD BE THOROUGHLY IRRIGATED WEEKLY DURING DRY PERIODS. PREPARATIONS FOR FINAL LANDSCAPING SHALL BE ACCOMPLISHED BY HAND WITHIN THE DRIP-LINES OF

RETAINED TREES. LARGE EQUIPMENT SHALL BE KEPT OUTSIDE OF THE TREE PROTECTION ZONES AT ALL TIMES. SIMPLY FINISH LANDSCAPE WITHIN DRIP-LINES OF RETAINED TREES WITH A 2"TO 4"LAYER OF

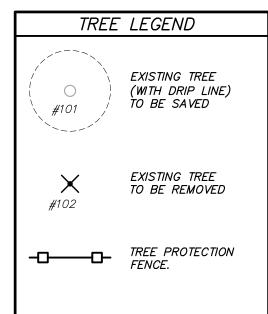

TREES WITH DIAMETERS LESS THAN SIX INCHES ARE CONSIDERED NON-SIGNIFICANT.

> SEE ARCHITECTURAL PLANS FOR DEMOLITION DETAILS.

FOLLOWING DEMOLITION AND PRIOR TO CONSTRUCTION, PROPOSED BUILDING WITH EXCAVATION LIMITS SHALL BE MARKED IN THE FIELD.

CONTRACTOR MAY RELOCATE TESC FACILITIES (SEDIMENT TRAP AND INTERCEPTOR SWALE) AS NEEDED TO FACILITATE CONSTRUCTION.

DUE TO ITS SIZE, THIS PROJECT MUST OBTAIN COVERAGE UNDER THE NPDES BASELINE PERMIT FOR DISCHARGE OF STORMWATER RUNOFF DURING CONSTRUCTION. A SEPARATE STORM WATER POLLUTION PREVENTION PLAN (SWPPP) HAS BEEN DEVELOPED FOR THIS PROJECT, INCORPORATING THE TEMPORARY EROSION CONTROL MEASURES DEPICTED HEREON. THE CONTRACTOR SHALL OBTAIN A COPY OF THE NPDES PERMIT AND THE SWPPP AND REFER TO IT FOR ADDITIONAL REQUIREMENTS AND GUIDANCE RELATED TO CONSTRUCTION PERIOD STORM WATER MANAGEMENT - PARTICULARLY MONITORING REQUIREMENTS AND SUPPLEMENTAL MEASURES TO BE IMPLEMENTED SHOULD SITE CONDITIONS WARRANT ADDITIONAL PROTECTION.

LOCATION OF EXISTING UTILITIES SHOWN IS APPROXIMATE AND MAY NOT BE ACCURATE OR ALL INCLUSIVE. IT IS THE CONTRACTOR'S RESPONSIBILITY TO FIELD VERIFY LOCATION OF UTILITIES PRIOR TO PROCEEDING WITH CONSTRUCTION. YOU MUST CALL 1-800-424-5555 NOT LESS THAN TWO FULL BUSINESS DAYS BEFORE BEGINNING EXCAVATION WHERE ANY UNDERGROUND UTILITIES MAY BE LOCATED. FAILURE TO DO SO COULD MEAN BEARING SUBSTANTIAL REPAIR COSTS.

20300 Woodinville Snohomish Rd NE Suite A • Woodinville, WA 98072 p: 425.415.2000 f: 425.486.5059 w: triadassociates.net

RICHARD A. TOMKINS, PE


PROJECT MANAGER PROJECT SURVEYOR PROJECT ENGINEER

PROJECT LANDSCAPE ARCHITECT FIRST SUBMITTAL DATE: SCALE: HORIZ.: 1"=20' VERT.: N/A



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LDYB0002

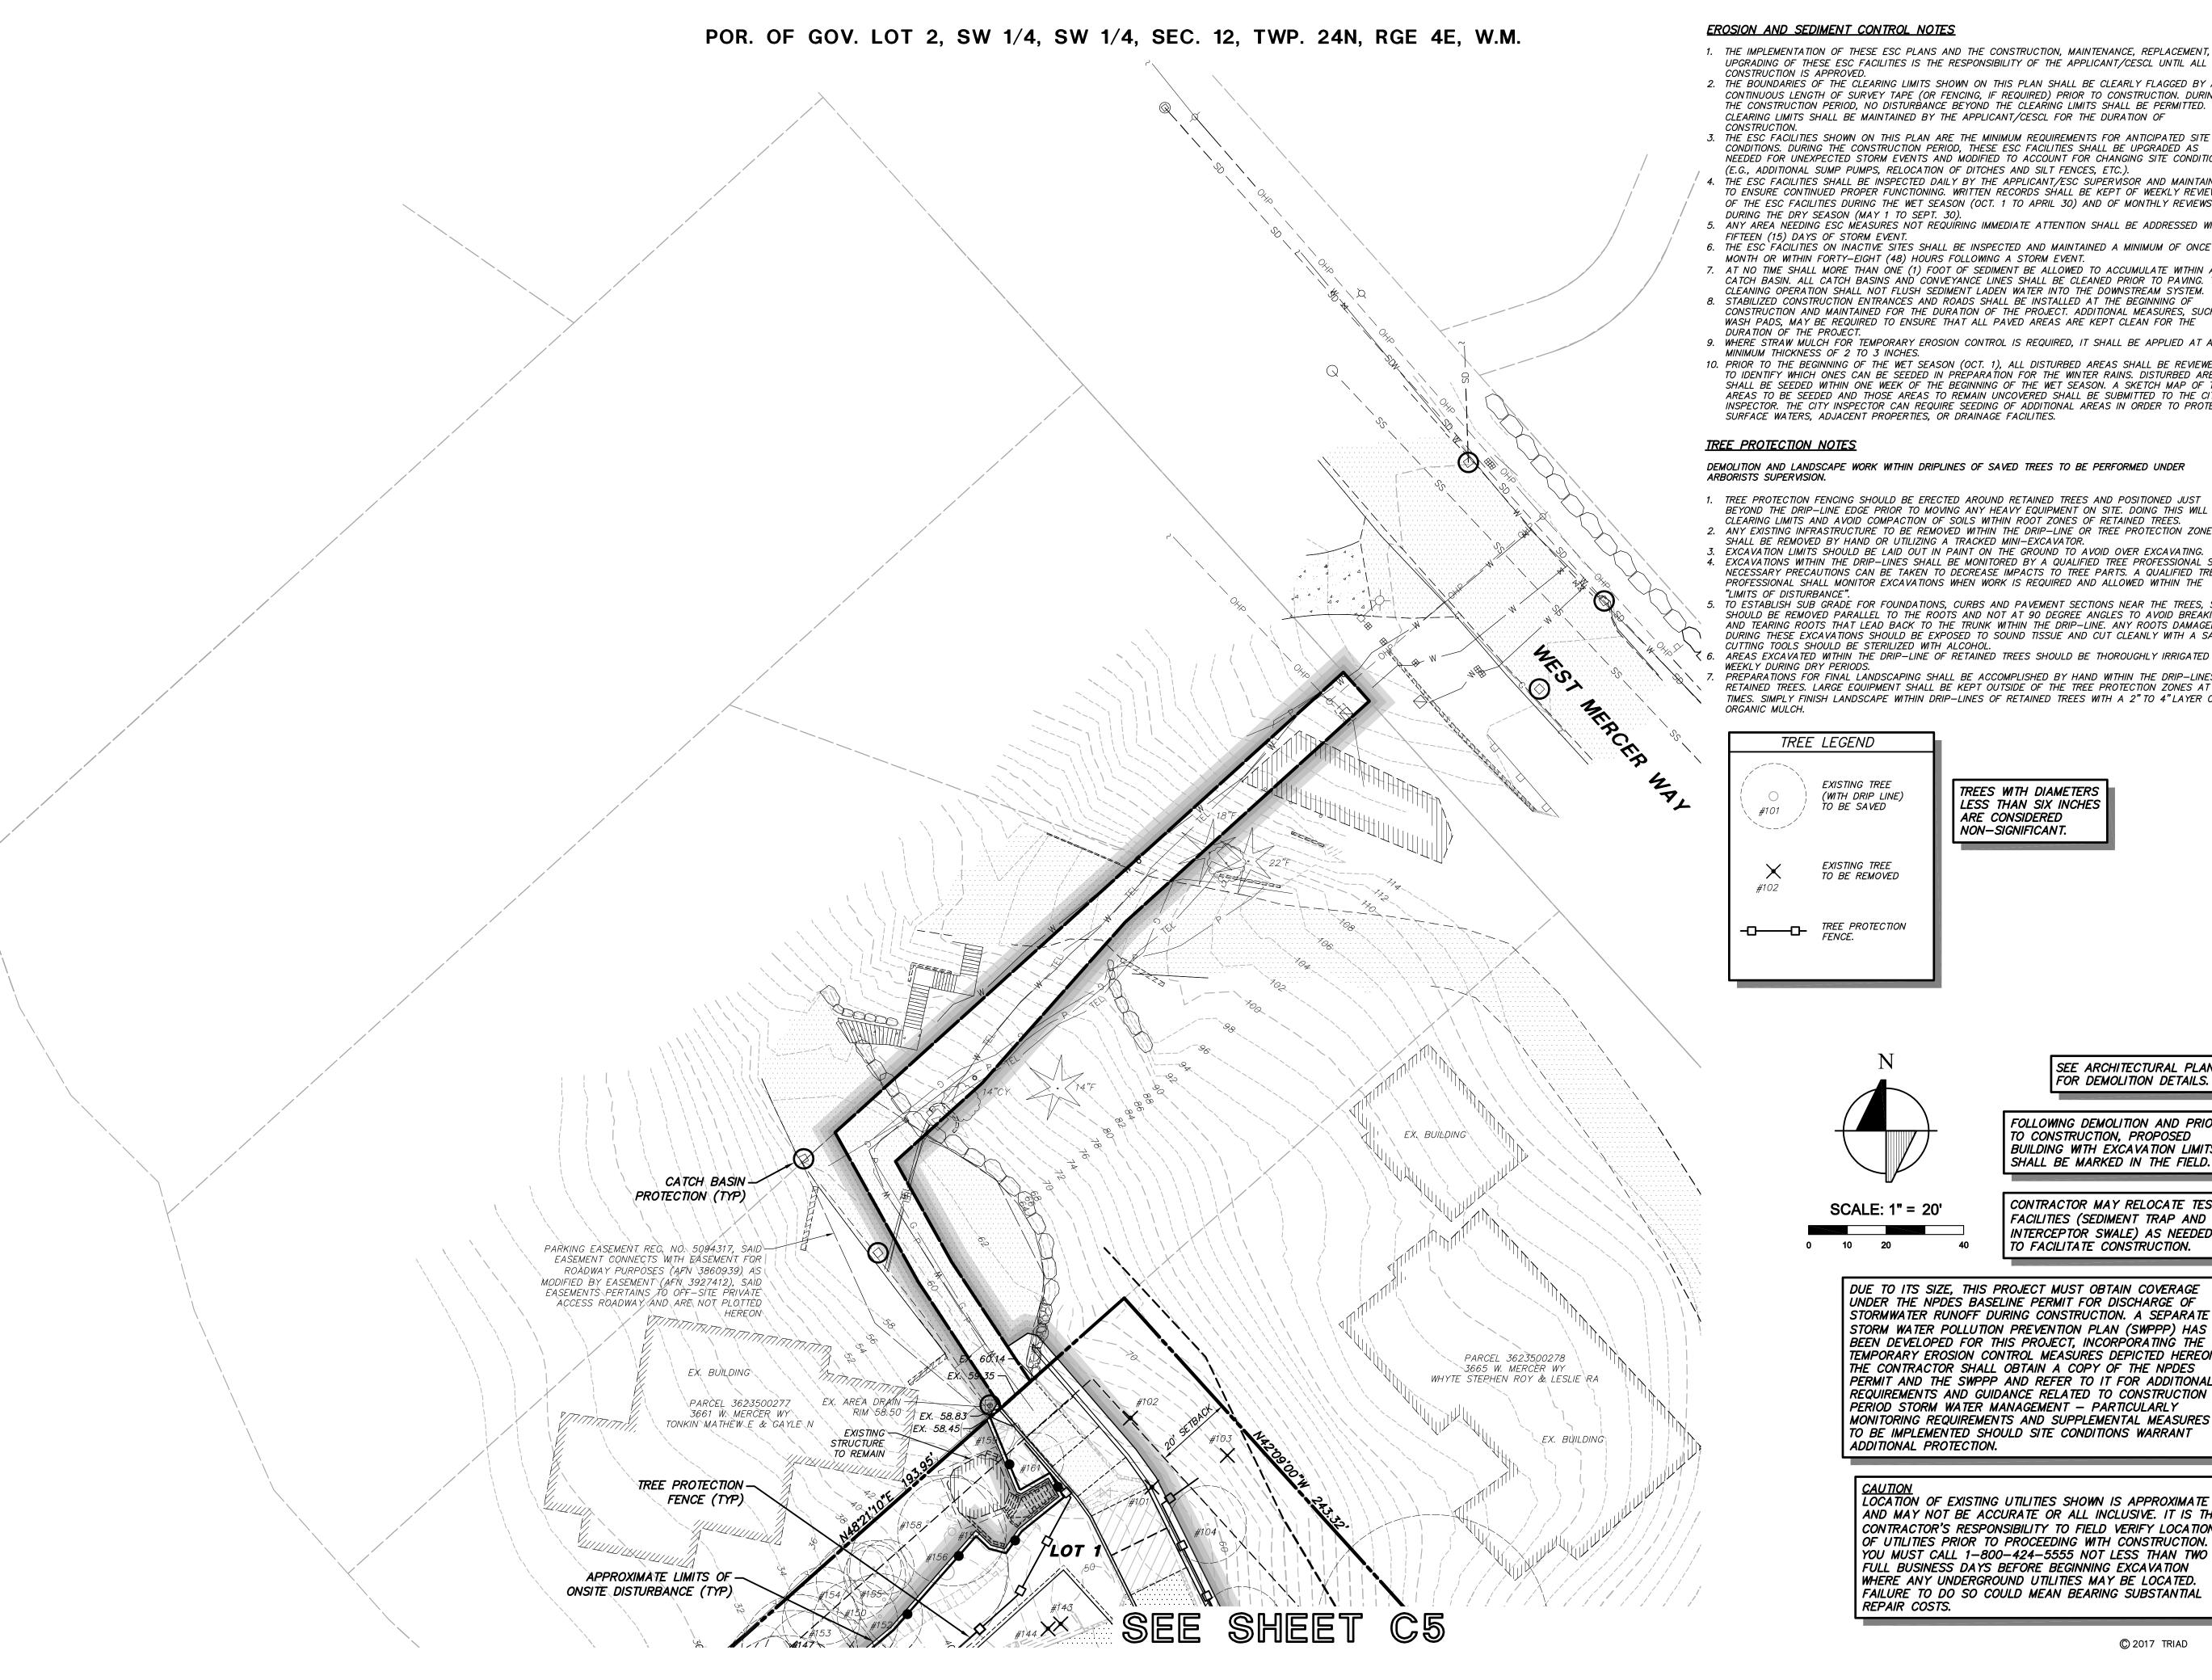


### EROSION AND SEDIMENT CONTROL NOTES

- 1. THE IMPLEMENTATION OF THESE ESC PLANS AND THE CONSTRUCTION, MAINTENANCE, REPLACEMENT, AND UPGRADING OF THESE ESC FACILITIES IS THE RESPONSIBILITY OF THE APPLICANT/CESCL UNTIL ALL
- 2. THE BOUNDARIES OF THE CLEARING LIMITS SHOWN ON THIS PLAN SHALL BE CLEARLY FLAGGED BY A CONTINUOUS LENGTH OF SURVEY TAPE (OR FENCING, IF REQUIRED) PRIOR TO CONSTRUCTION. DURING THE CONSTRUCTION PERIOD, NO DISTURBANCE BEYOND THE CLEARING LIMITS SHALL BE PERMITTED. THE CLEARING LIMITS SHALL BE MAINTAINED BY THE APPLICANT/CESCL FOR THE DURATION OF
- 3. THE ESC FACILITIES SHOWN ON THIS PLAN ARE THE MINIMUM REQUIREMENTS FOR ANTICIPATED SITE CONDITIONS. DURING THE CONSTRUCTION PERIOD, THESE ESC FACILITIES SHALL BE UPGRADED AS NEEDED FOR UNEXPECTED STORM EVENTS AND MODIFIED TO ACCOUNT FOR CHANGING SITE CONDITIONS (E.G., ADDITIONAL SUMP PUMPS, RELOCATION OF DITCHES AND SILT FENCES, ETC.).
- 4. THE ESC FACILITIES SHALL BE INSPECTED DAILY BY THE APPLICANT/ESC SUPERVISOR AND MAINTAINED TO ENSURE CONTINUED PROPER FUNCTIONING. WRITTEN RECORDS SHALL BE KEPT OF WEEKLY REVIEWS OF THE ESC FACILITIES DURING THE WET SEASON (OCT. 1 TO APRIL 30) AND OF MONTHLY REVIEWS
- DURING THE DRY SEASON (MAY 1 TO SEPT. 30). 5. ANY AREA NEEDING ESC MEASURES NOT REQUIRING IMMEDIATE ATTENTION SHALL BE ADDRESSED WITHIN
- 6. THE ESC FÁCILITIES ON INACTIVE SITES SHALL BE INSPECTED AND MAINTAINED A MINIMUM OF ONCE A
- MONTH OR WITHIN FORTY-EIGHT (48) HOURS FOLLOWING A STORM EVENT.
- 7. AT NO TIME SHALL MORE THAN ONE (1) FOOT OF SEDIMENT BE ALLOWED TO ACCUMULATE WITHIN A CATCH BASIN. ALL CATCH BASINS AND CONVEYANCE LINES SHALL BE CLEANED PRIOR TO PAVING. THE CLEANING OPERATION SHALL NOT FLUSH SEDIMENT LADEN WATER INTO THE DOWNSTREAM SYSTEM. 8. STABILIZED CONSTRUCTION ENTRANCES AND ROADS SHALL BE INSTALLED AT THE BEGINNING OF
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- MINIMUM THICKNESS OF 2 TO 3 INCHES. 10. PRIOR TO THE BEGINNING OF THE WET SEASON (OCT. 1), ALL DISTURBED AREAS SHALL BE REVIEWED
- TO IDENTIFY WHICH ONES CAN BE SEEDED IN PREPARATION FOR THE WINTER RAINS. DISTURBED AREAS SHALL BE SEEDED WITHIN ONE WEEK OF THE BEGINNING OF THE WET SEASON. A SKETCH MAP OF THOSE AREAS TO BE SEEDED AND THOSE AREAS TO REMAIN UNCOVERED SHALL BE SUBMITTED TO THE CITY INSPECTOR. THE CITY INSPECTOR CAN REQUIRE SEEDING OF ADDITIONAL AREAS IN ORDER TO PROTECT SURFACE WATERS, ADJACENT PROPERTIES, OR DRAINAGE FACILITIES.

DEMOLITION AND LANDSCAPE WORK WITHIN DRIPLINES OF SAVED TREES TO BE PERFORMED UNDER ARBORISTS SUPERVISION.

- 1. TREE PROTECTION FENCING SHOULD BE ERECTED AROUND RETAINED TREES AND POSITIONED JUST BEYOND THE DRIP-LINE EDGE PRIOR TO MOVING ANY HEAVY EQUIPMENT ON SITE. DOING THIS WILL SET CLEARING LIMITS AND AVOID COMPACTION OF SOILS WITHIN ROOT ZONES OF RETAINED TREES. 2. ANY EXISTING INFRASTRUCTURE TO BE REMOVED WITHIN THE DRIP-LINE OR TREE PROTECTION ZONE
- 3. EXCAVATION LIMITS SHOULD BE LAID OUT IN PAINT ON THE GROUND TO AVOID OVER EXCAVATING. L. EXCAVATIONS WITHIN THE DRIP—LINES SHALL BE MONITORED BY A QUALIFIED TREE PROFESSIONAL SO NECESSARY PRECAUTIONS CAN BE TAKEN TO DECREASE IMPACTS TO TREE PARTS. A QUALIFIED TREE PROFESSIONAL SHALL MONITOR EXCAVATIONS WHEN WORK IS REQUIRED AND ALLOWED WITHIN THE
- 5. TO ESTABLISH SUB GRADE FOR FOUNDATIONS, CURBS AND PAVEMENT SECTIONS NEAR THE TREES, SOIL SHOULD BE REMOVED PARALLEL TO THE ROOTS AND NOT AT 90 DEGREE ANGLES TO AVOID BREAKING AND TEARING ROOTS THAT LEAD BACK TO THE TRUNK WITHIN THE DRIP-LINE. ANY ROOTS DAMAGED DURING THESE EXCAVATIONS SHOULD BE EXPOSED TO SOUND TISSUE AND CUT CLEANLY WITH A SAW. CUTTING TOOLS SHOULD BE STERILIZED WITH ALCOHOL.
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FOLLOWING DEMOLITION AND PRIOR TO CONSTRUCTION, PROPOSED

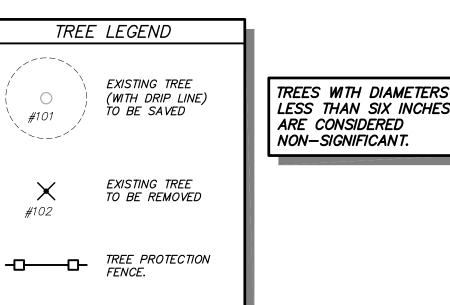SCALE: 1" = 20'

CONTRACTOR MAY RELOCATE TESC FACILITIES (SEDIMENT TRAP AND INTERCEPTOR SWALE) AS NEEDED TO FACILITATE CONSTRUCTION.

BUILDING WITH EXCAVATION LIMITS

SHALL BE MARKED IN THE FIELD.

SEE ARCHITECTURAL PLANS FOR DEMOLITION DETAILS.

DUE TO ITS SIZE, THIS PROJECT MUST OBTAIN COVERAGE UNDER THE NPDES BASELINE PERMIT FOR DISCHARGE OF STORMWATER RUNOFF DURING CONSTRUCTION. A SEPARATE STORM WATER POLLUTION PREVENTION PLAN (SWPPP) HAS BEEN DEVELOPED FOR THIS PROJECT, INCORPORATING THE TEMPORARY EROSION CONTROL MEASURES DEPICTED HEREON. THE CONTRACTOR SHALL OBTAIN A COPY OF THE NPDES PERMIT AND THE SWPPP AND REFER TO IT FOR ADDITIONAL REQUIREMENTS AND GUIDANCE RELATED TO CONSTRUCTION PERIOD STORM WATER MANAGEMENT - PARTICULARLY MONITORING REQUIREMENTS AND SUPPLEMENTAL MEASURES TO BE IMPLEMENTED SHOULD SITE CONDITIONS WARRANT ADDITIONAL PROTECTION.

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20300 Woodinville Snohomish Rd NE Suite A • Woodinville, WA 98072 p: 425.415.2000 f: 425.486.5059 w: triadassociates.net

RICHARD A. TOMKINS, PE PROJECT MANAGER MARY MCDOWELL, PLS PROJECT SURVEYOR

PROJECT ENGINEER PROJECT LANDSCAPE ARCHITECT FIRST SUBMITTAL DATE: SCALE: HORIZ.: 1"=20' VERT.: N/A



STAMP NOT VALID UNLESS SIGNED AND DATED

LDYB0002

**C6** of **7** 

### LEGAL DESCRIPTION

(PER QUIT CLAIM DEED AFN 9405052361) LOB B OF MERCER ISLAND SHORT PLAT NO. MI-76-8-027, AS RECORDED UNDER RECORDING NO. 7702170577, AND AS AMANDED BY BOUNDARY LINE REVISION PER CITY OF MERCER ISLAND FILE NO. MI-81-08-15 AS RECORDED UNDER RECORDING NO. 8211169001, SAID SHORT PLAT BEING A PORTION OF BLOCK A, REPLAT OF ISLAND PARK, ACCORDING TO THE PLAT THEROF RECORDED IN VOLUME 13 OF PLATS, PAGE 58, IN KING COUNTY, WASHINGTON.

### BASIS OF BEARINGS

HELD BEARING N 40°36'45" W, BETWEEN EXISTING TACKS SET IN LEAD BY H.W. RUTHERFORD IN 1959, AS SHOWN HEREON AND REFERENCED IN R1

### REFERENCES

. THIS SURVEY IS A DEPENDANT RETRACEMENT OF MERCER ISLAND B.L.R. NO. MI-82-08-15, AS RECORDED UNDER K.C.R.N. 8211169001. THIS SURVEY IS BASED UPON EXISTING POINTS RECOVERED, AND SHOWN THERREON.


### VERTICAL DATUM


NAVD88 PER WGS SURVEY DATA WAREHOUSE POINT DESIGNATION-8037, 2" BRASS CAP IN 4" CONC. MON (DN 0.3') WEST MERCER WAY AT JOG 100' SE OF INTX LAKE PL. 950' NW IF INTX SE 40TH ST ELEV.=171.06'


### SURVEYOR'S NOTES


- 1. THE TOPOGRAPHIC SURVEY SHOWN HEREON WAS PERFORMED IN JULY OF 2016. THE FIELD DATA WAS COLLECTED AND RECORDED ON MAGNETIC MEDIA THROUGH AN ELECTRONIC THEODOLITE. THE DATA FILE IS ARCHIVED ON DISC OR CD. WRITTEN FIELD NOTES MAY NOT EXIST. CONTOURS ARE SHOWN FOR CONVENIENCE ONLY. DESIGN SHOULD RELY ON SPOT ELEVATIONS.
- 2. ALL MONUMENTS SHOWN HEREON WERE LOCATED DURING THE COURSE OF THIS SURVEY UNLESS OTHERWISE NOTED.
- 3. BURIED UTILITIES SHOWN BASED ON RECORDS FURNISHED BY OTHERS AND VERIFIED WHERE POSSIBLE IN THE FIELD. GEODIMENSIONS ASSUMES NO LIABILITY FOR THE ACCURACY OF THOSE RECORDS OR ACCEPT RESPONSIBILITY FOR UNDERGROUND LINES WHICH ARE NOT MADE PUBLIC RECORD. FOR THE FINAL LOCATION OF EXISTING UTILITIES IN AREAS CRITICAL TO DESIGN CONTACT THE UTILITY OWNER/AGENCY. AS ALWAYS, CALL 1-800-424-5555 BEFORE CONSTRUCTION.
- 4. SUBJECT PROPERTY TAX PARCEL NO. 362350-0273, 362350-0274, 362350-0275.
- 5. TOTAL SUBJECT PROPERTY AREA PER THIS SURVEY IS 51,699± S.F. (1.19± ACRES)
- 6. THIS SURVEY WAS PERFORMED WITHOUT THE BENEFIT OF A TITLE REPORT. EASEMENTS AND OTHER ENCUMBRANCES MAY EXIST THAT ARE NOT SHOWN HEREON.
- 7. INSTRUMENTATION FOR THIS SURVEY WAS A TRIMBLE ELECTRONIC DISTANCE MEASURING UNIT. PROCEDURES USED IN THIS SURVEY WERE DIRECT AND REVERSE ANGLES, NO CORRECTION NECESSARY. MEETS STATE STANDARDS SET BY WAC 332-130-090.

### LEGEND

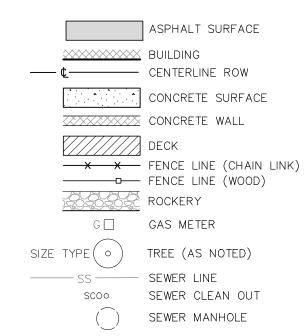

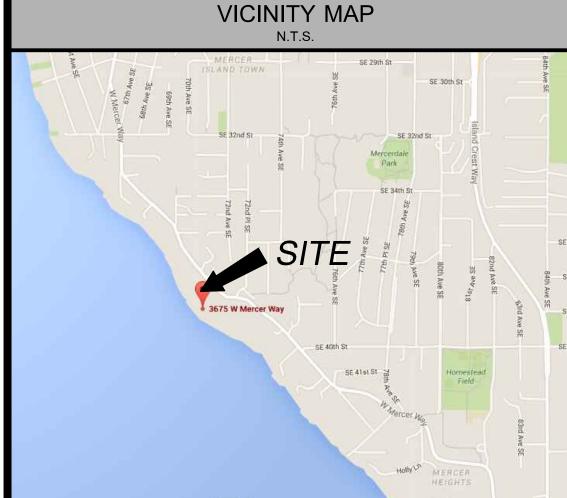


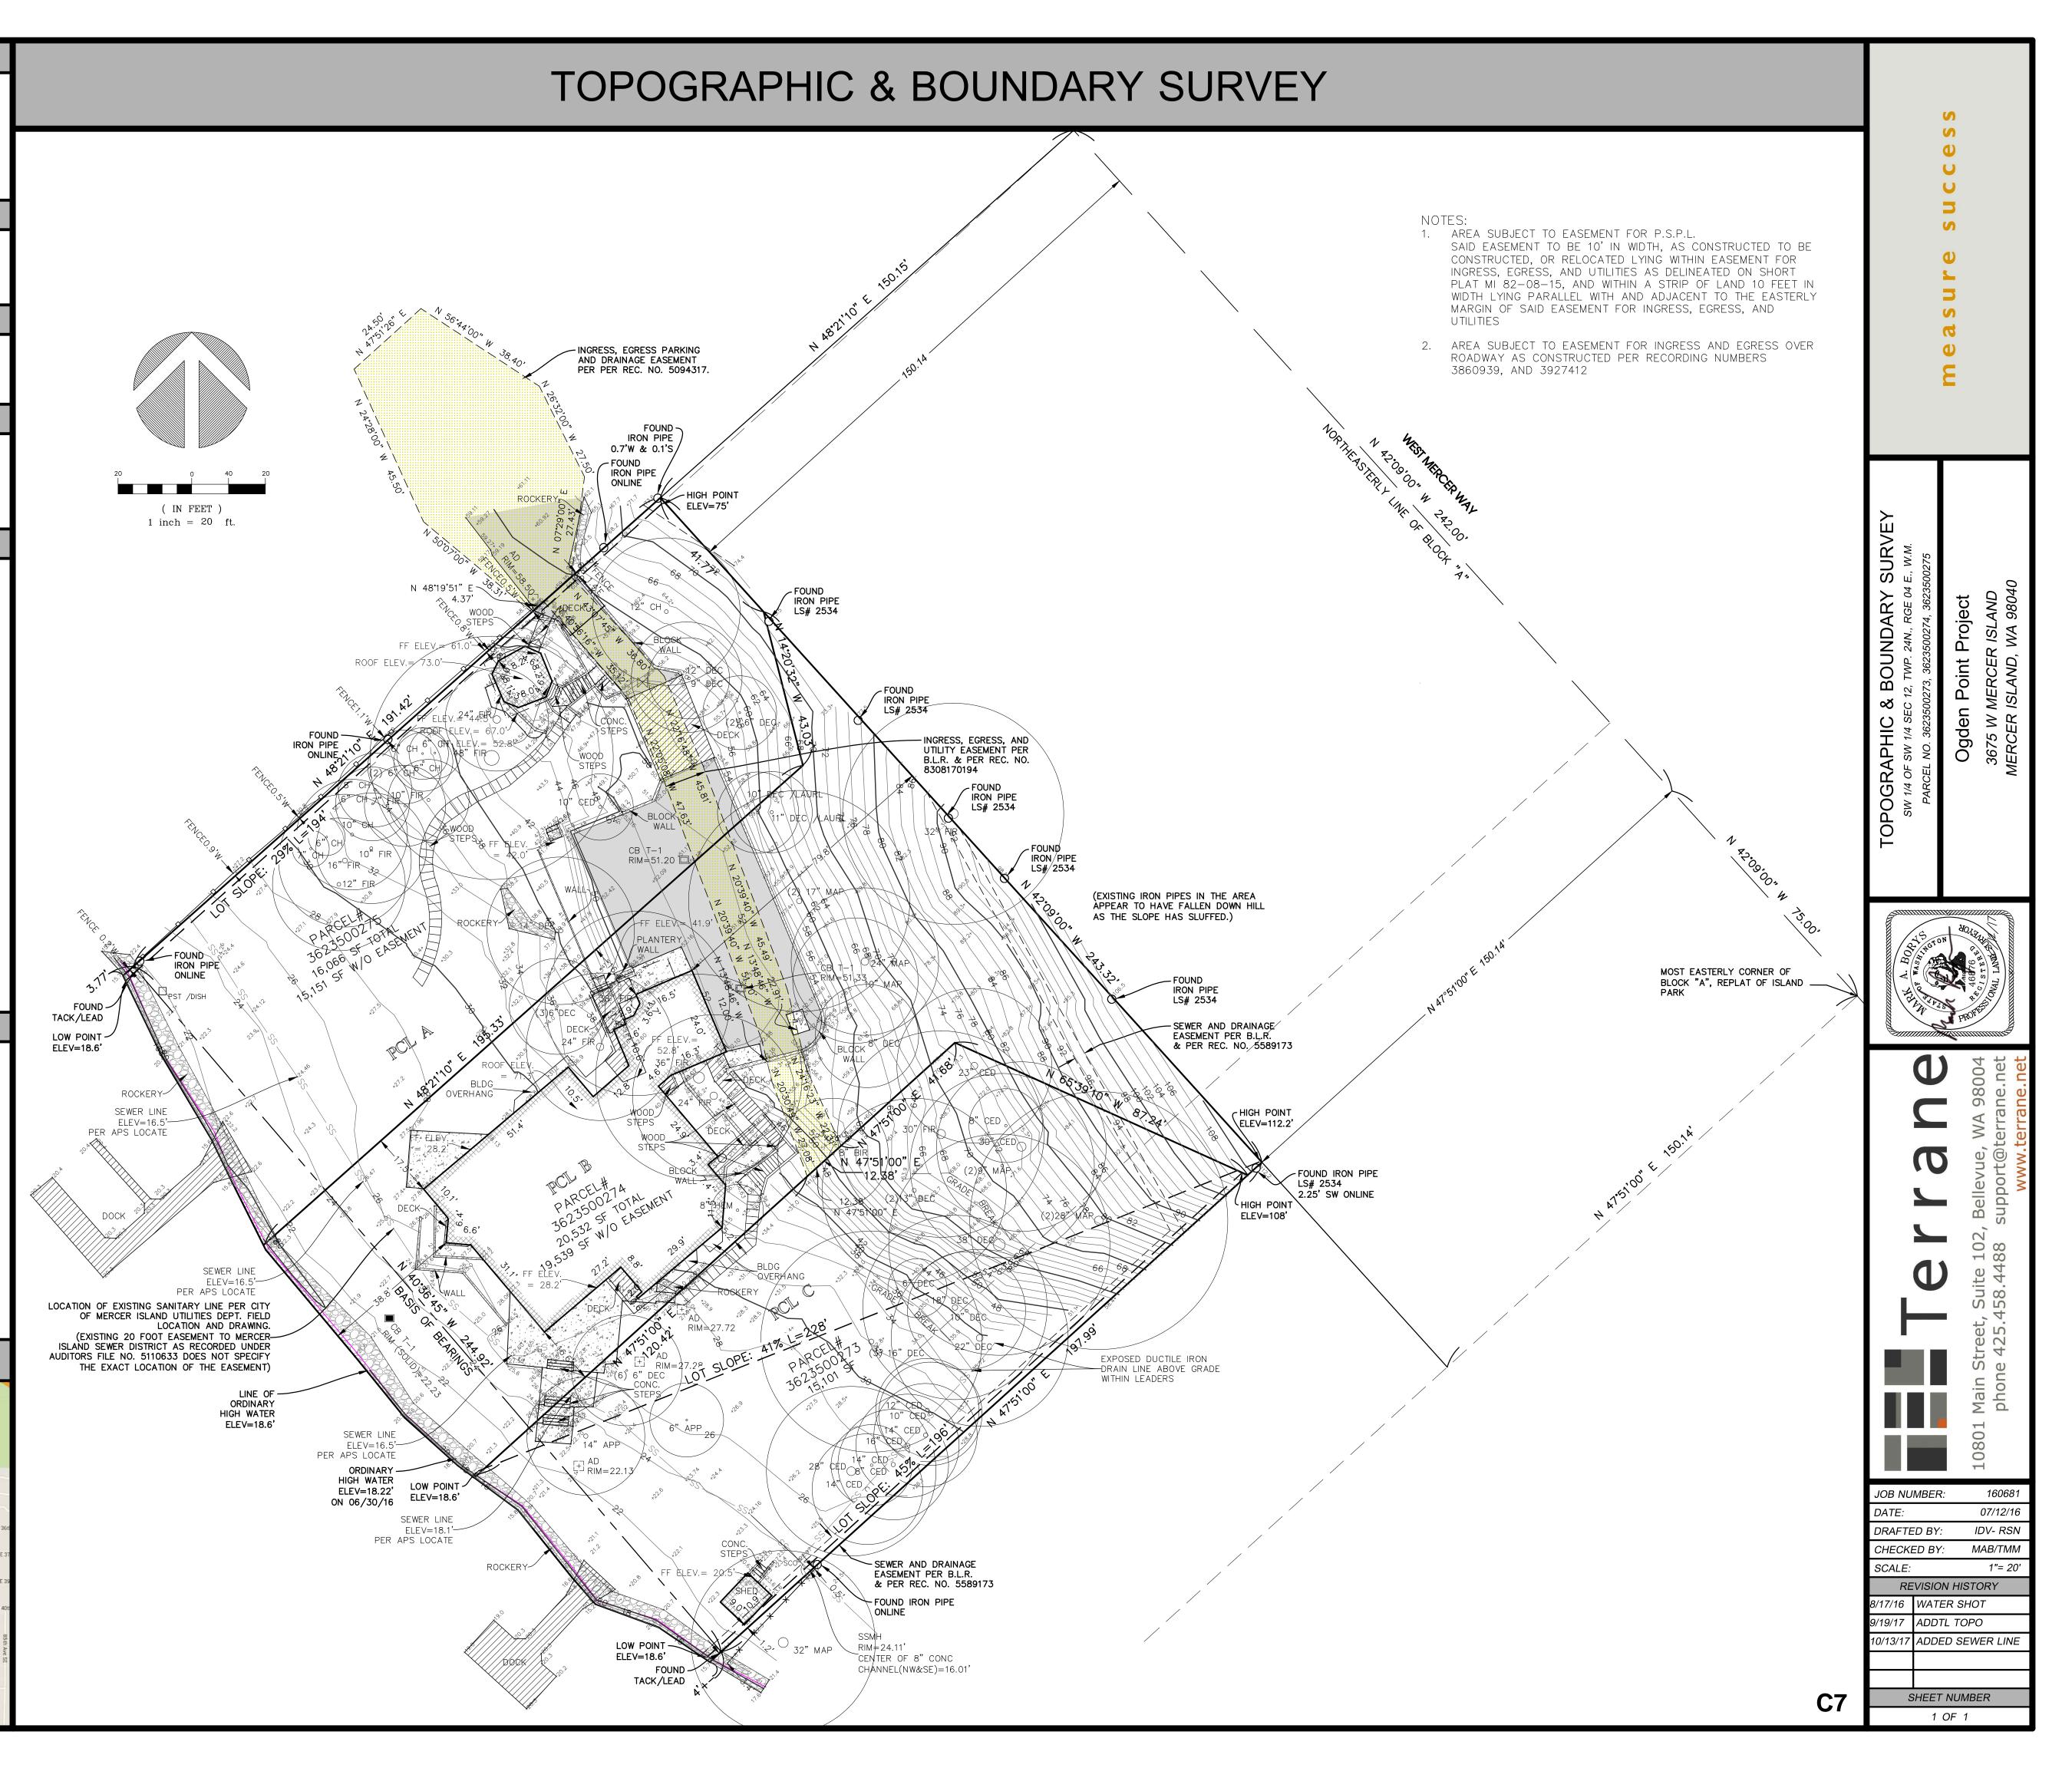

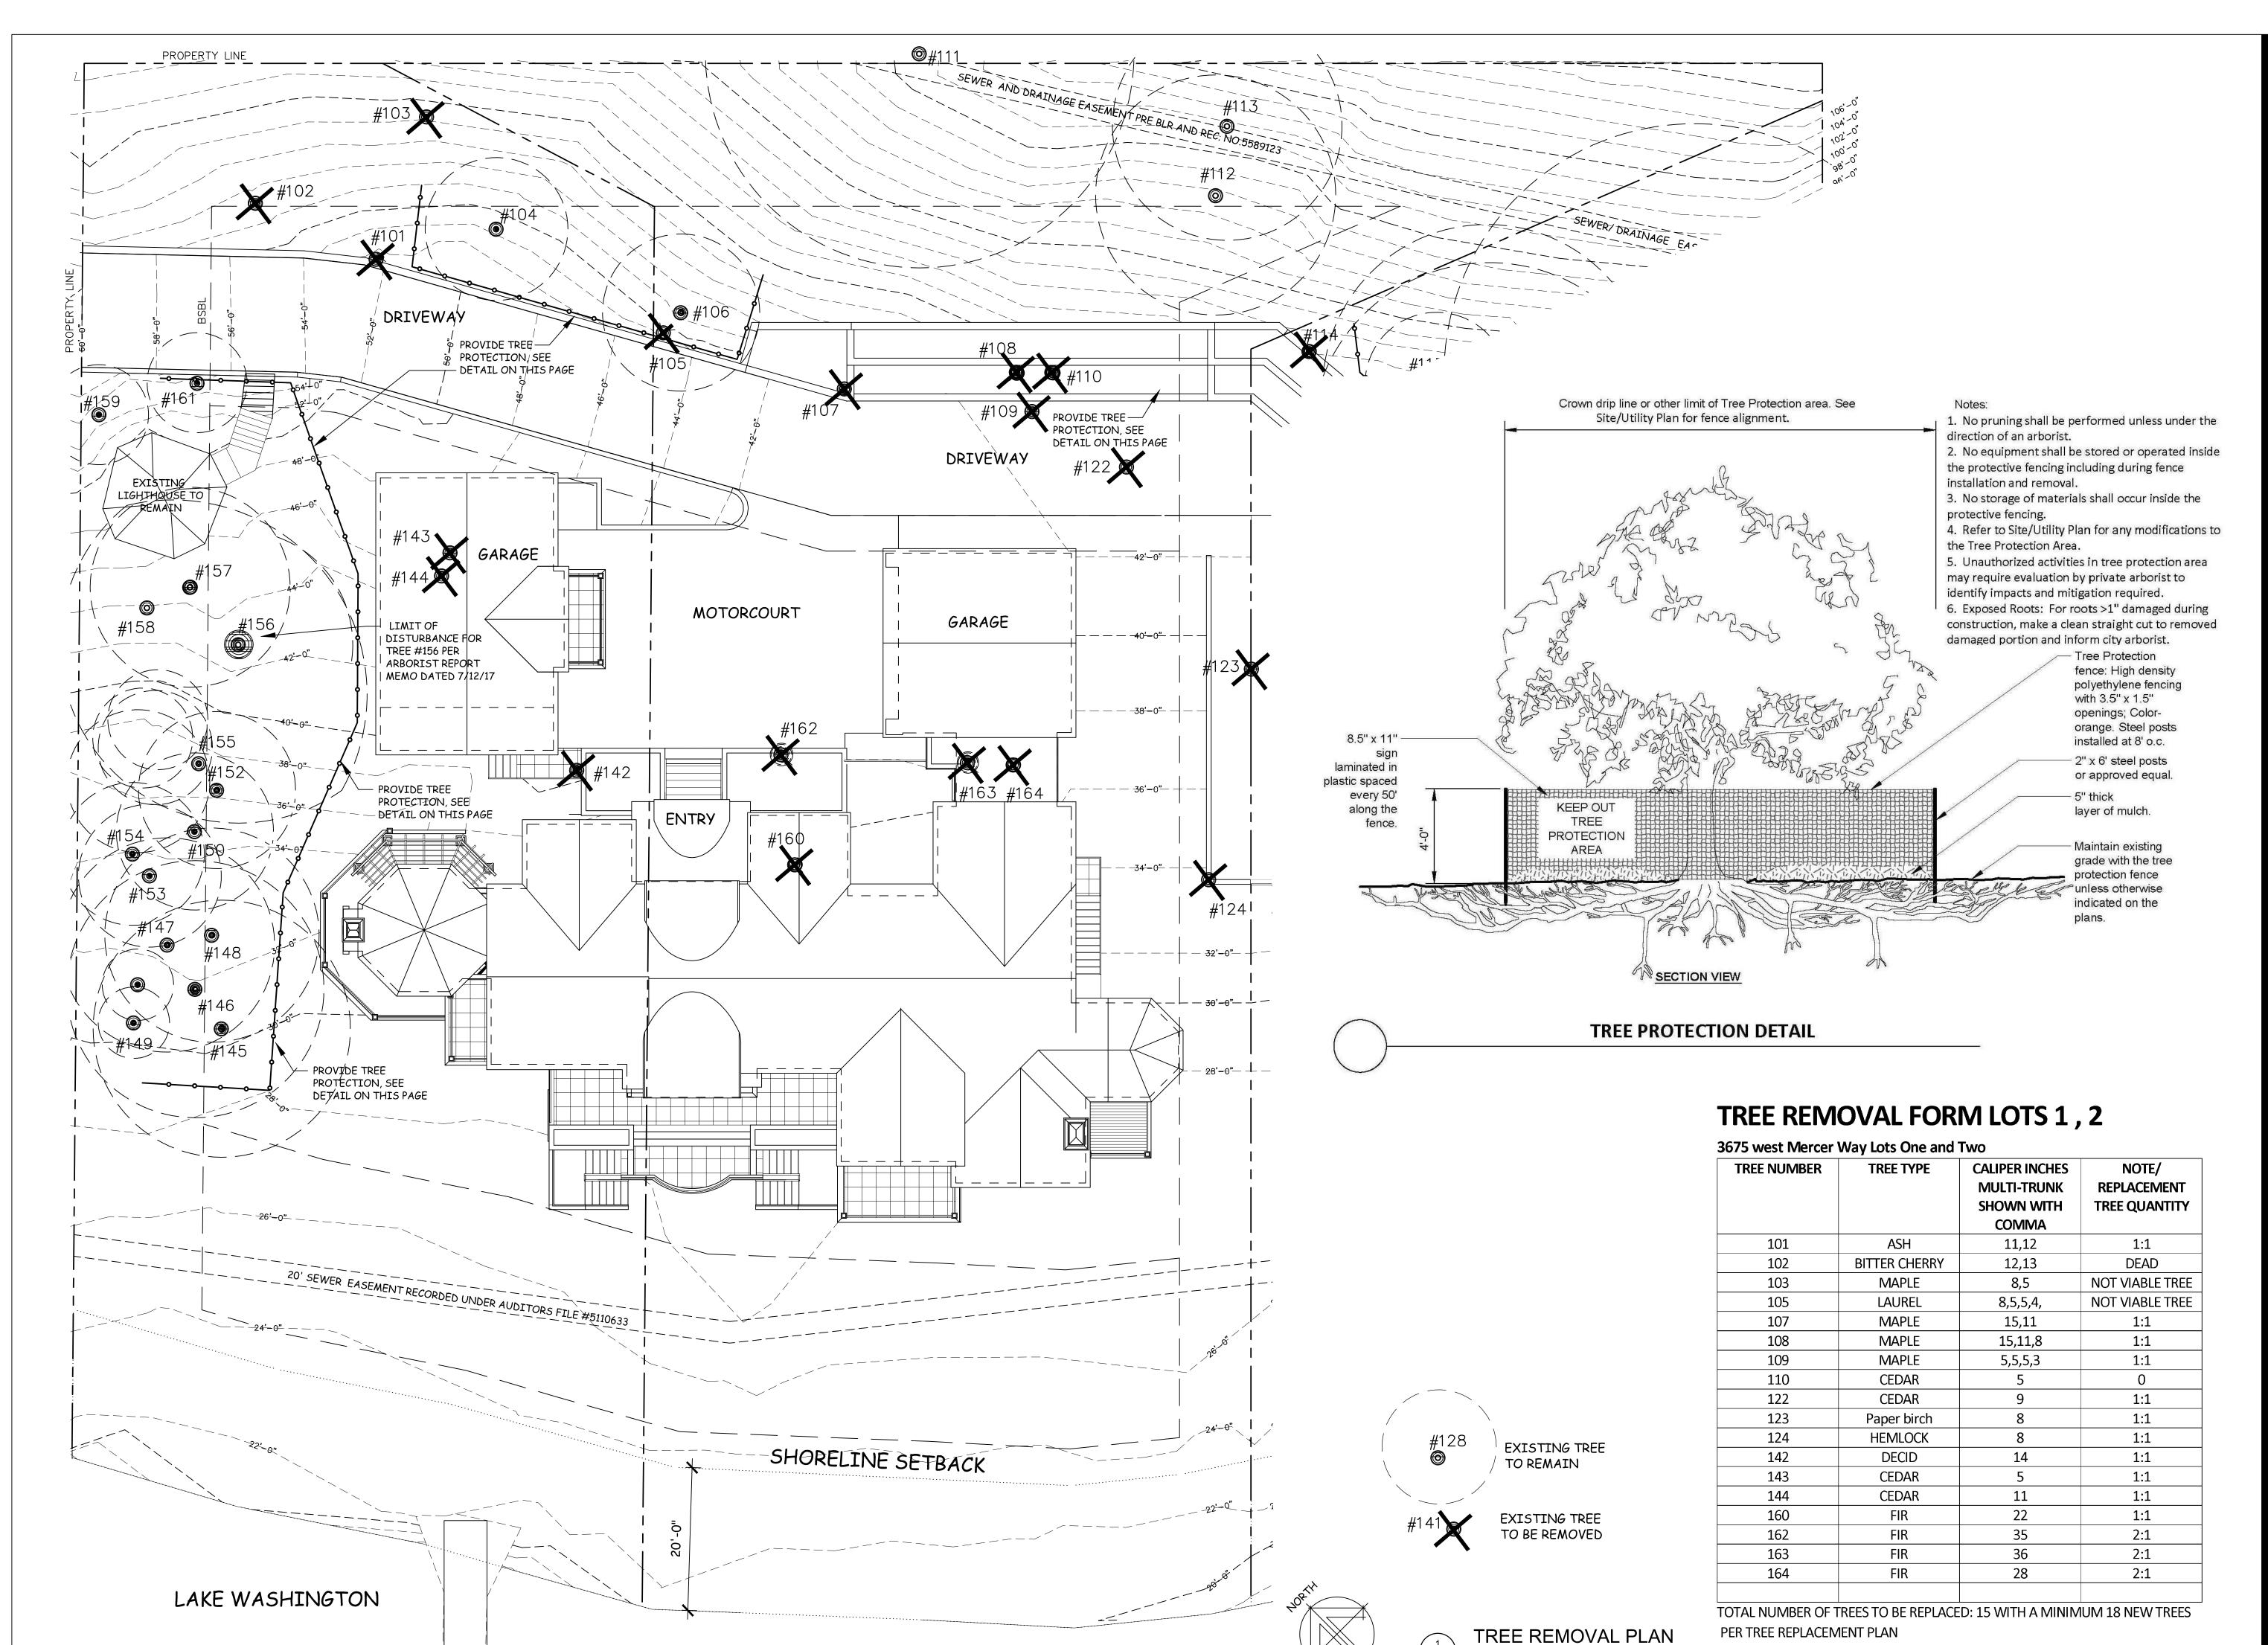

SCALE:1" = 10'-0"

LAKE WASHINGTON

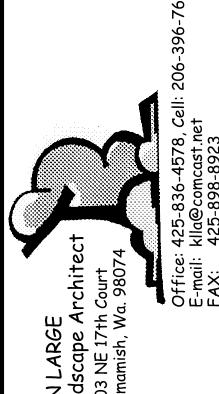



# 3675 W. MERCER WAY MERCER ISLAND, WASHINGTO


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DRAV	WN:	KE
CHEC	KED:	
DATE	E:	JULY 26, 2017
REVI	SIONS:	
1	08/14/2	17 PLAN REVIEW
2	10/25/1	7 PLANLUPDATE

SHEET TITLE:

TREE REMOVAL PLAN LOTS 1 & 2


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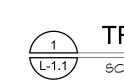
## TREE REMOVAL FORM LOT 3

**3675 west Mercer Way Lot Three** 

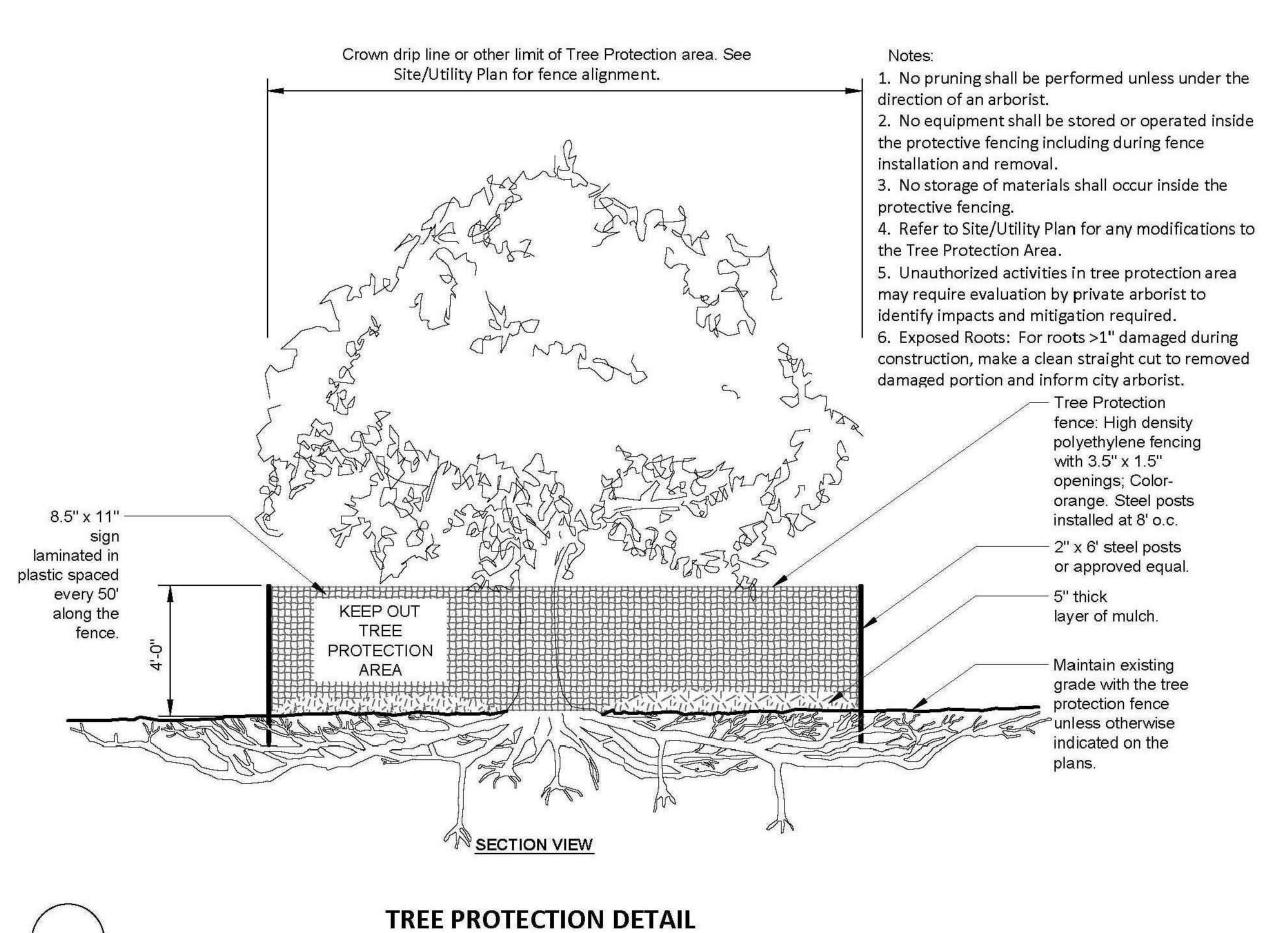


TREE NUMBER	TREE TYPE	CALIPER INCHES MULTI-TRUNK SHOWN WITH COMMA	NOTE/ REPLACEMENT TREE QUANTITY
114	CEDAR	26	2:1
119	DOUGLAS FIR	32	2:1
120	MADRONE	13,15	1:1
121	MADRONE	28,32	2:1
126	HORSE CHESTNUT	12	1:1
127	HORSE CHESTNUT	16,10,5	1:1
128	HORSE CHESTNUT	8,4	1:1
129	POPLAR	33.20	1:1
130	YELLOW WOOD	7,5,5,4	1:1
139	APPLE	8,6,4	1:1
140	MULBERRY?	3,3,4,4,5.5.5	1:1
141	APPLE	8,6,4	1:1

TREES PER TREE REPLACEMENT PLAN

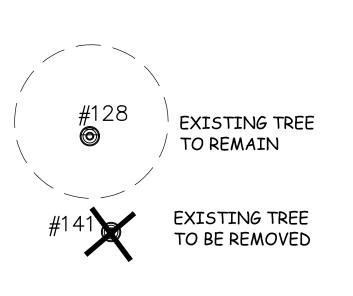

TREE REMOVAL PLAN SCALE:1" = 10'-0"

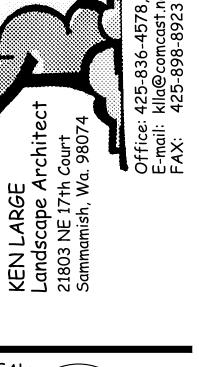




JOB NUMBER: DRAWN: CHECKED: JULY 26, 2017 REVISIONS: 1 08/14/17 PLAN REVIEW


2 | 10/25/17 PLAN UPDATE


SHEET TITLE:

TREE REMOVAL PLAN LOT 03

PERMIT SET SHEET NUMBER:

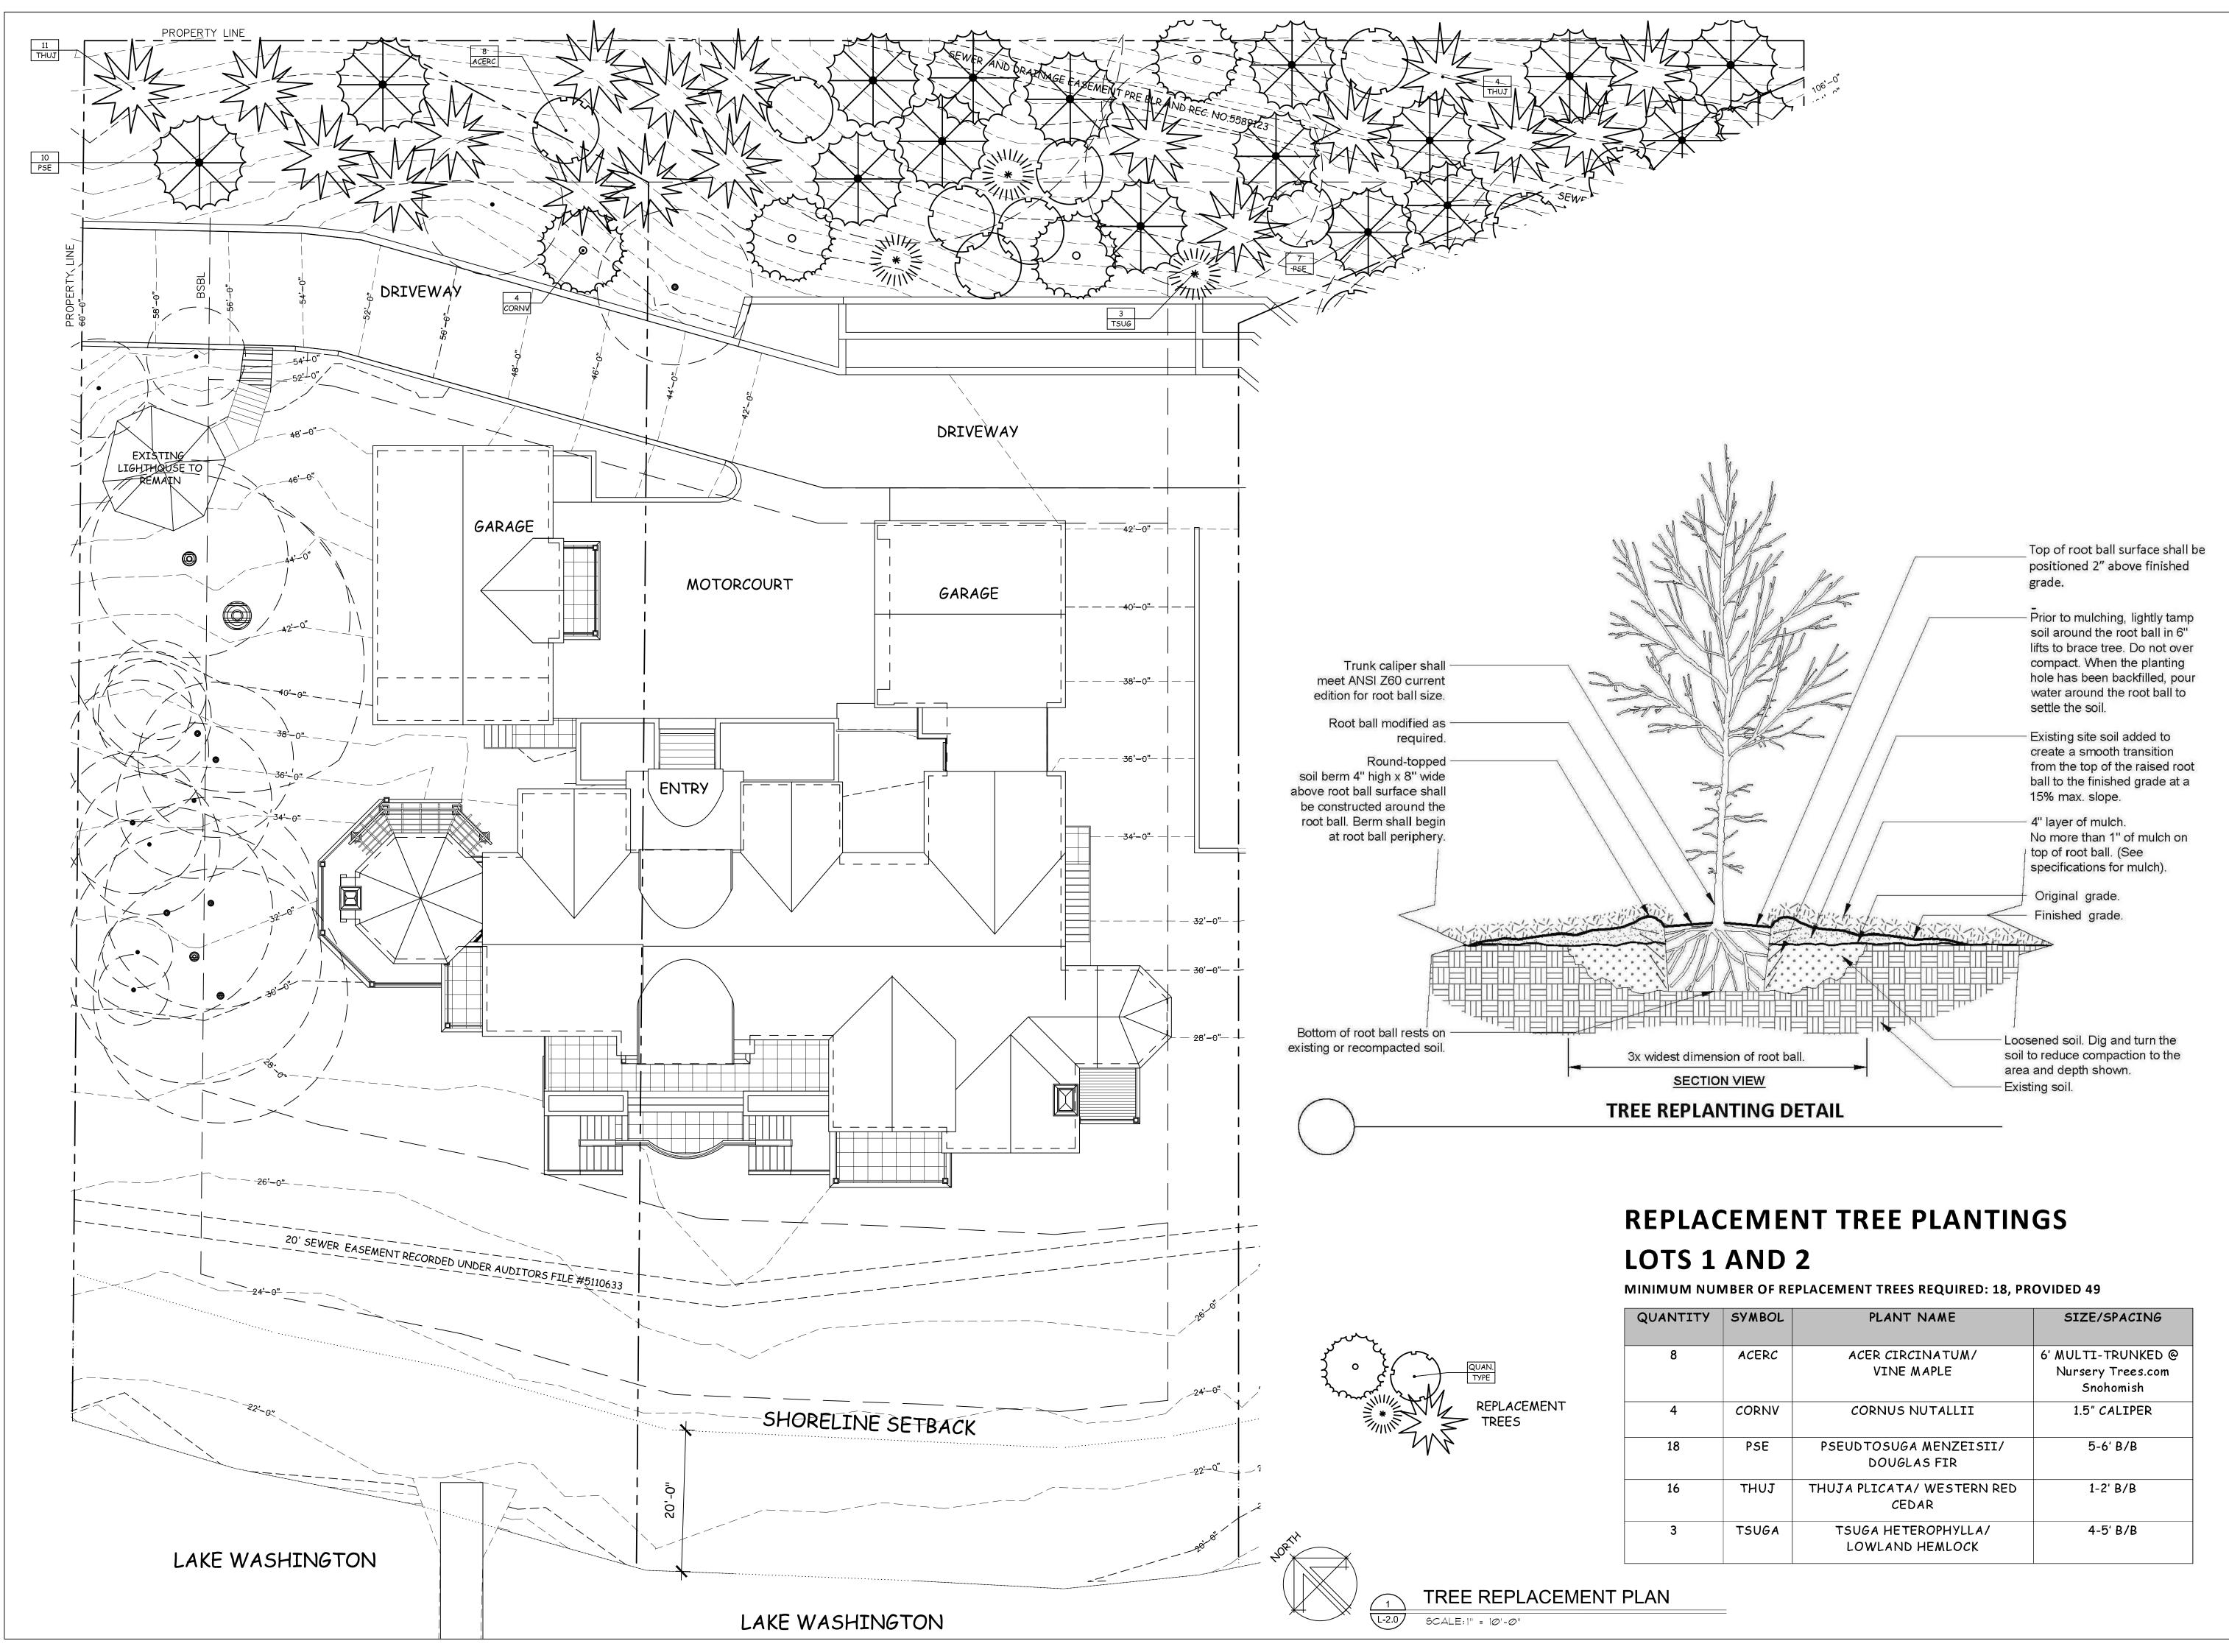

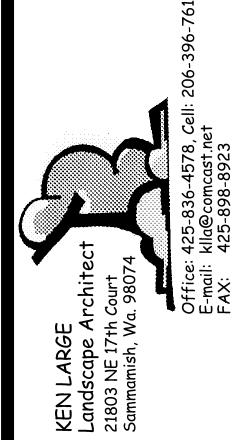

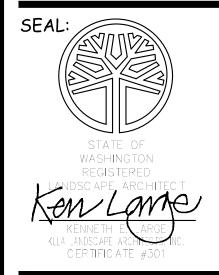

3675 W. MERCER WAY
MERCER ISLAND, WASHINGT


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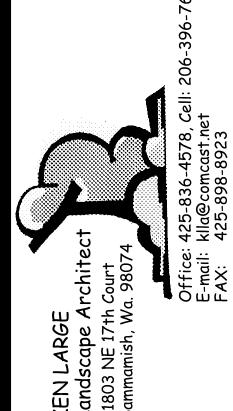
SHEET TITLE:

TREE
REPLACEMENT
PLAN
LOTS 1&2
PERMIT SET

SHEET NUMBER:

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# SDEN POINT 75 W. MERCER WAY ERCER ISLAND, WASHINGT

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JOB NUMBER:	
DRAWN:	K
CHECKED:	
DATE:	JULY 26, 201
REVISIONS:	

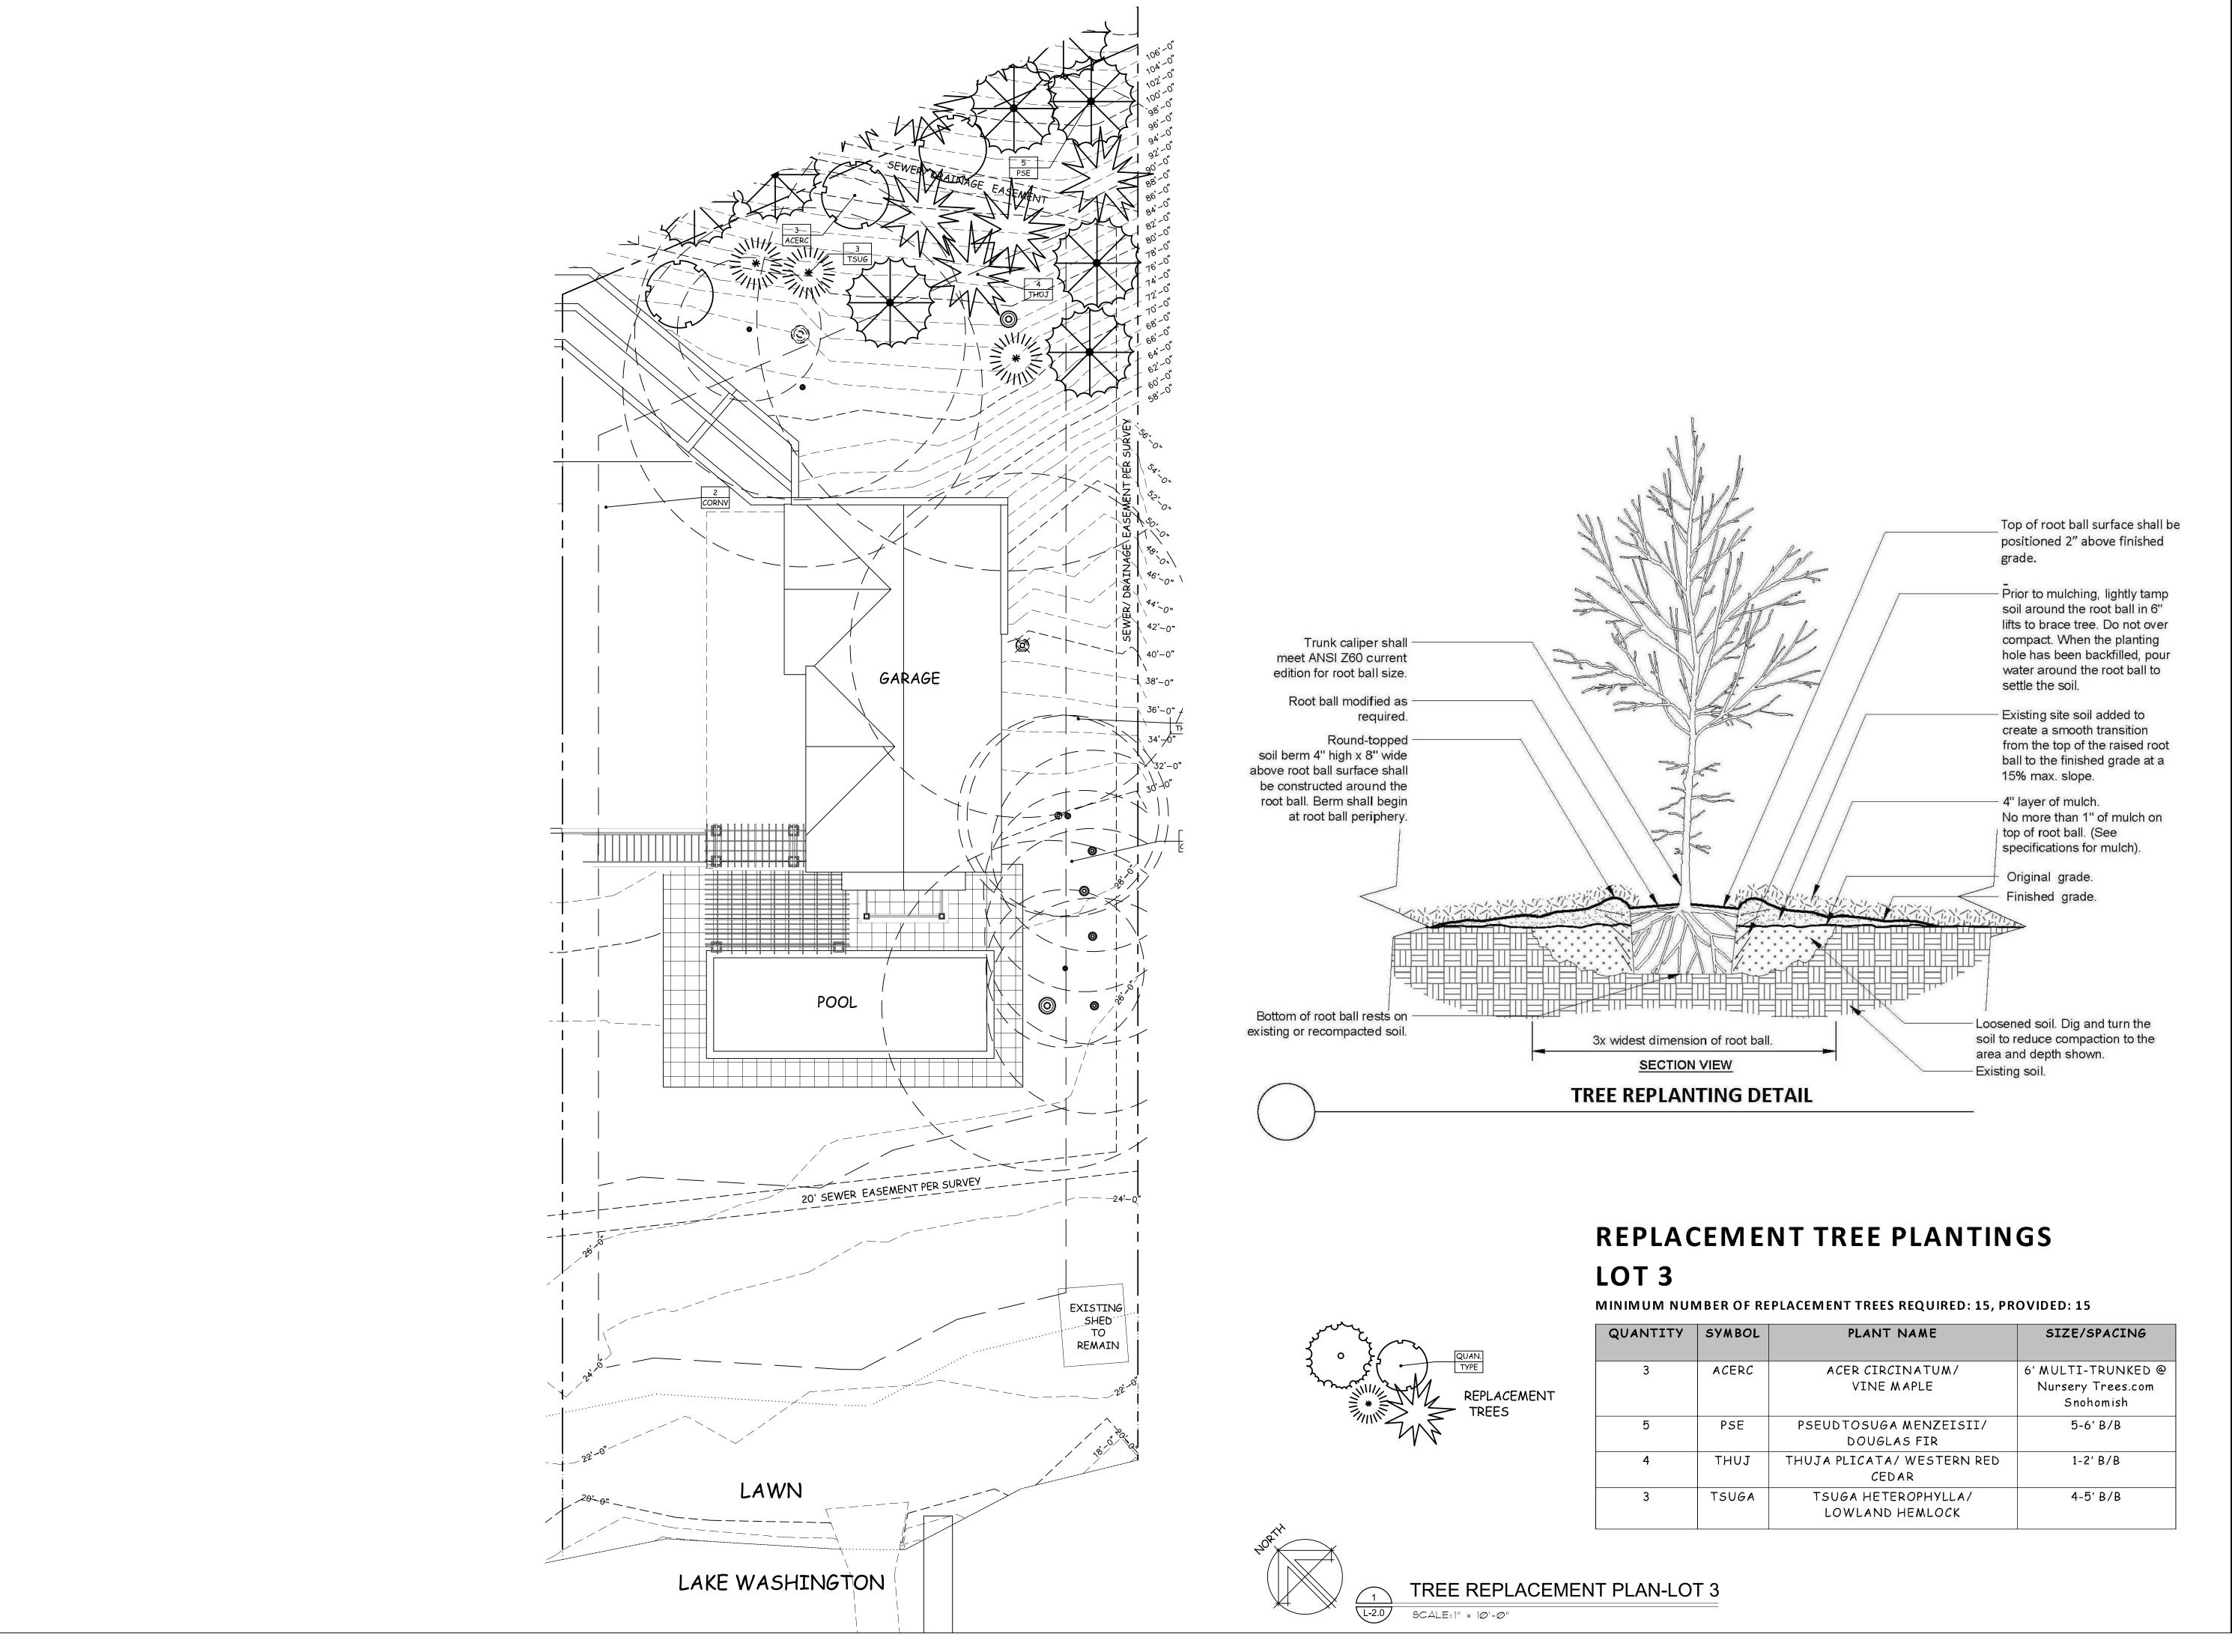
1 08/14/17 PLAN REVIEW 2 10/25/17 PLAN UPDATE


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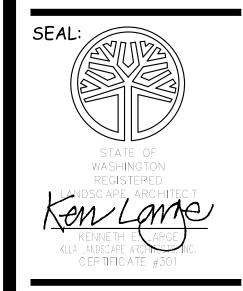
TREE REPLACEMENT PLAN LOT 3


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1\_21





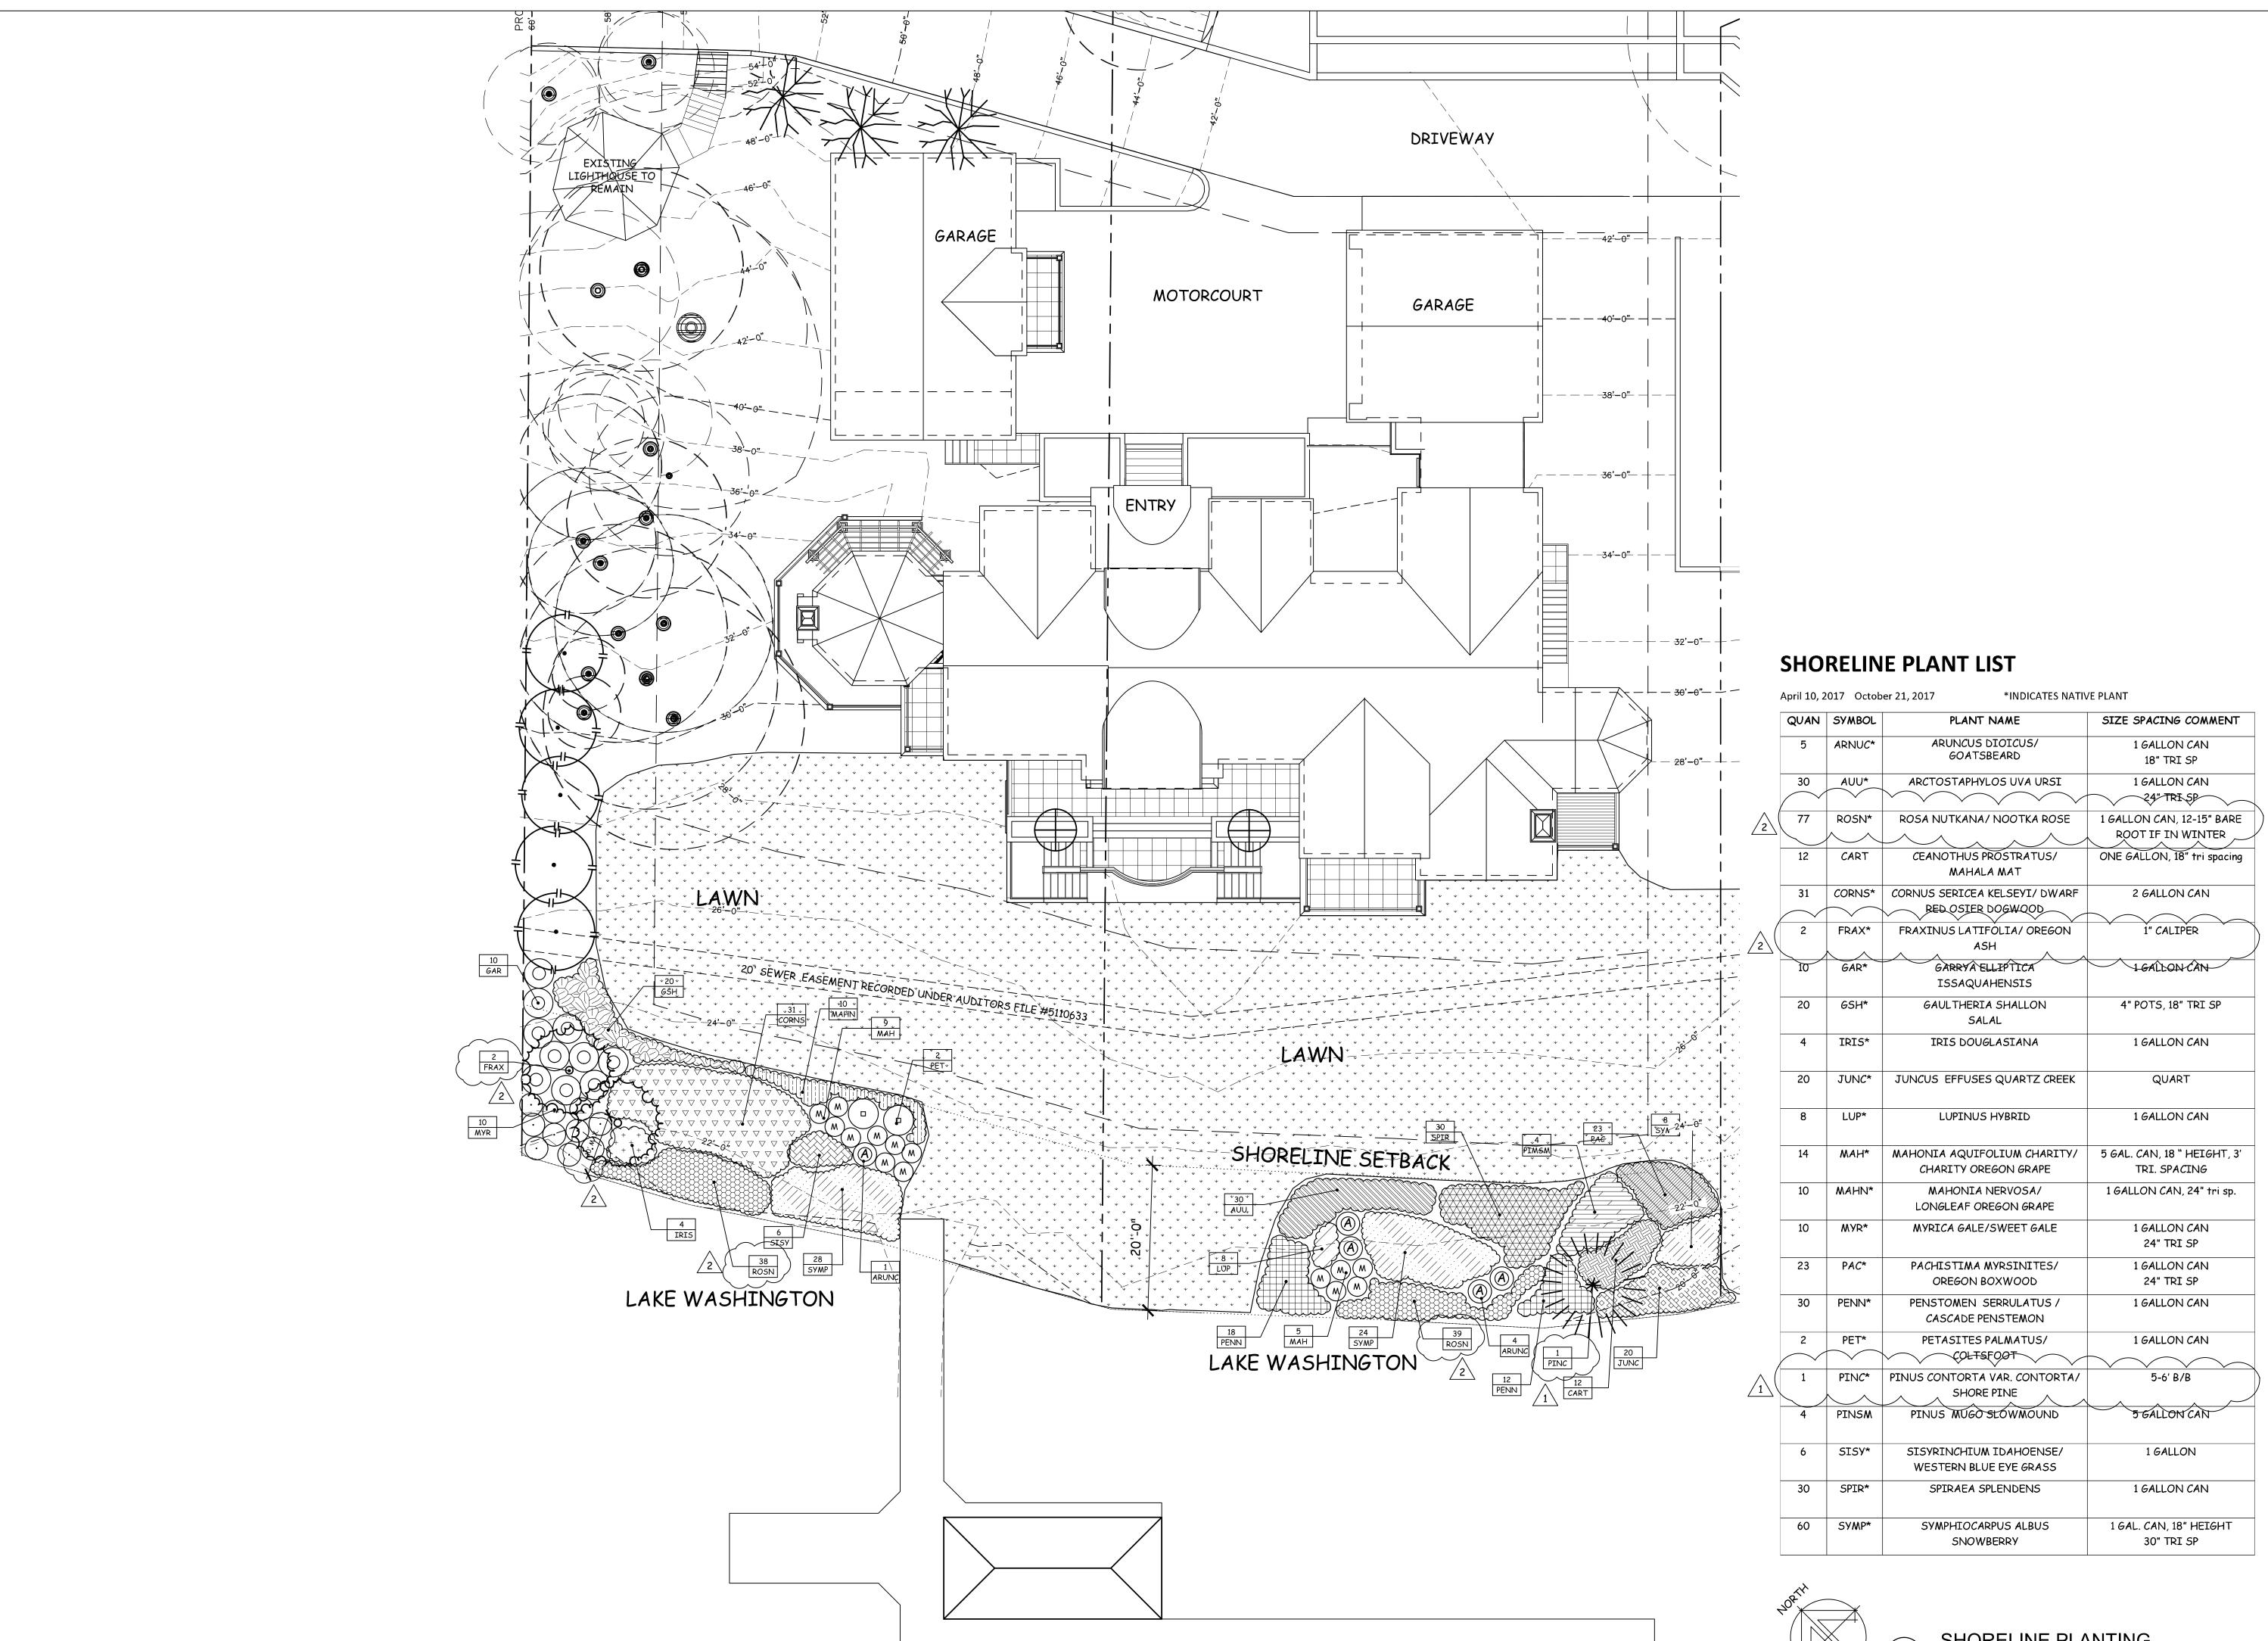

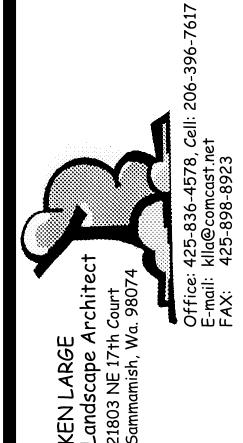

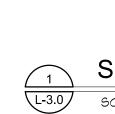SHORELINE PLANTING SCALE: |" = 10'-0"


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SHORELINE PLANTING PLAN LOTS 1 & 2 PERMIT SET

SHEET NUMBER:





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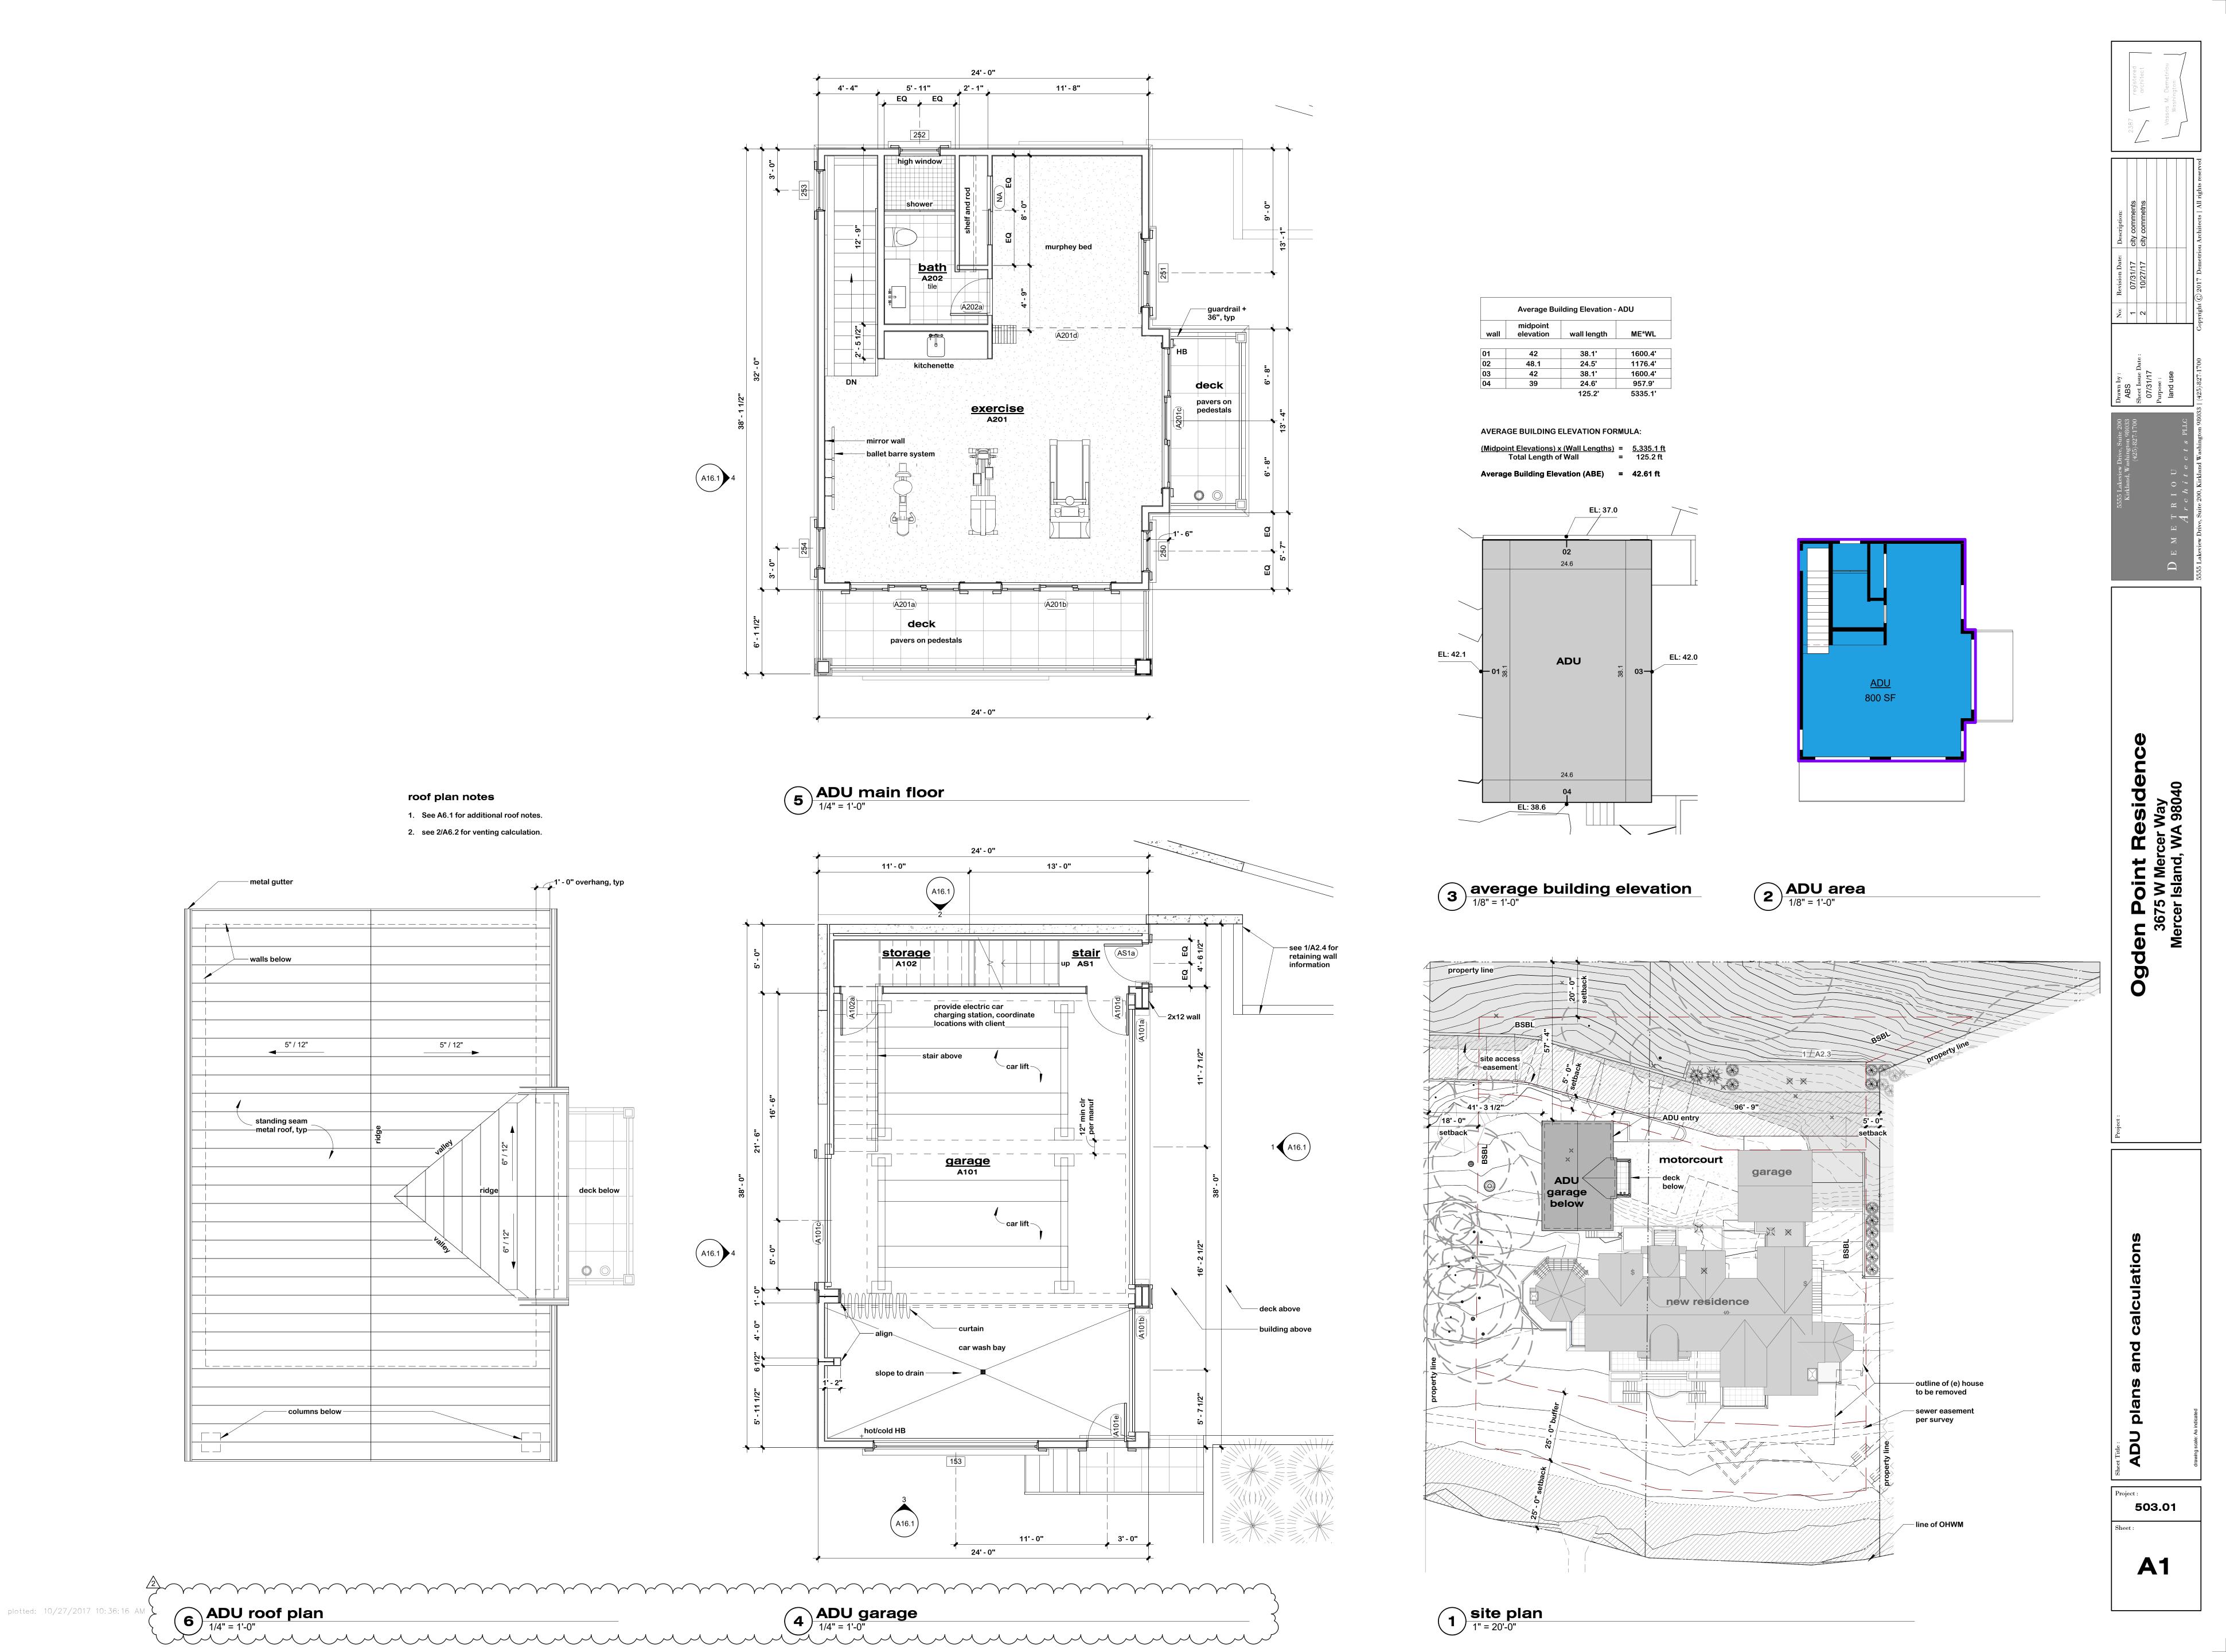
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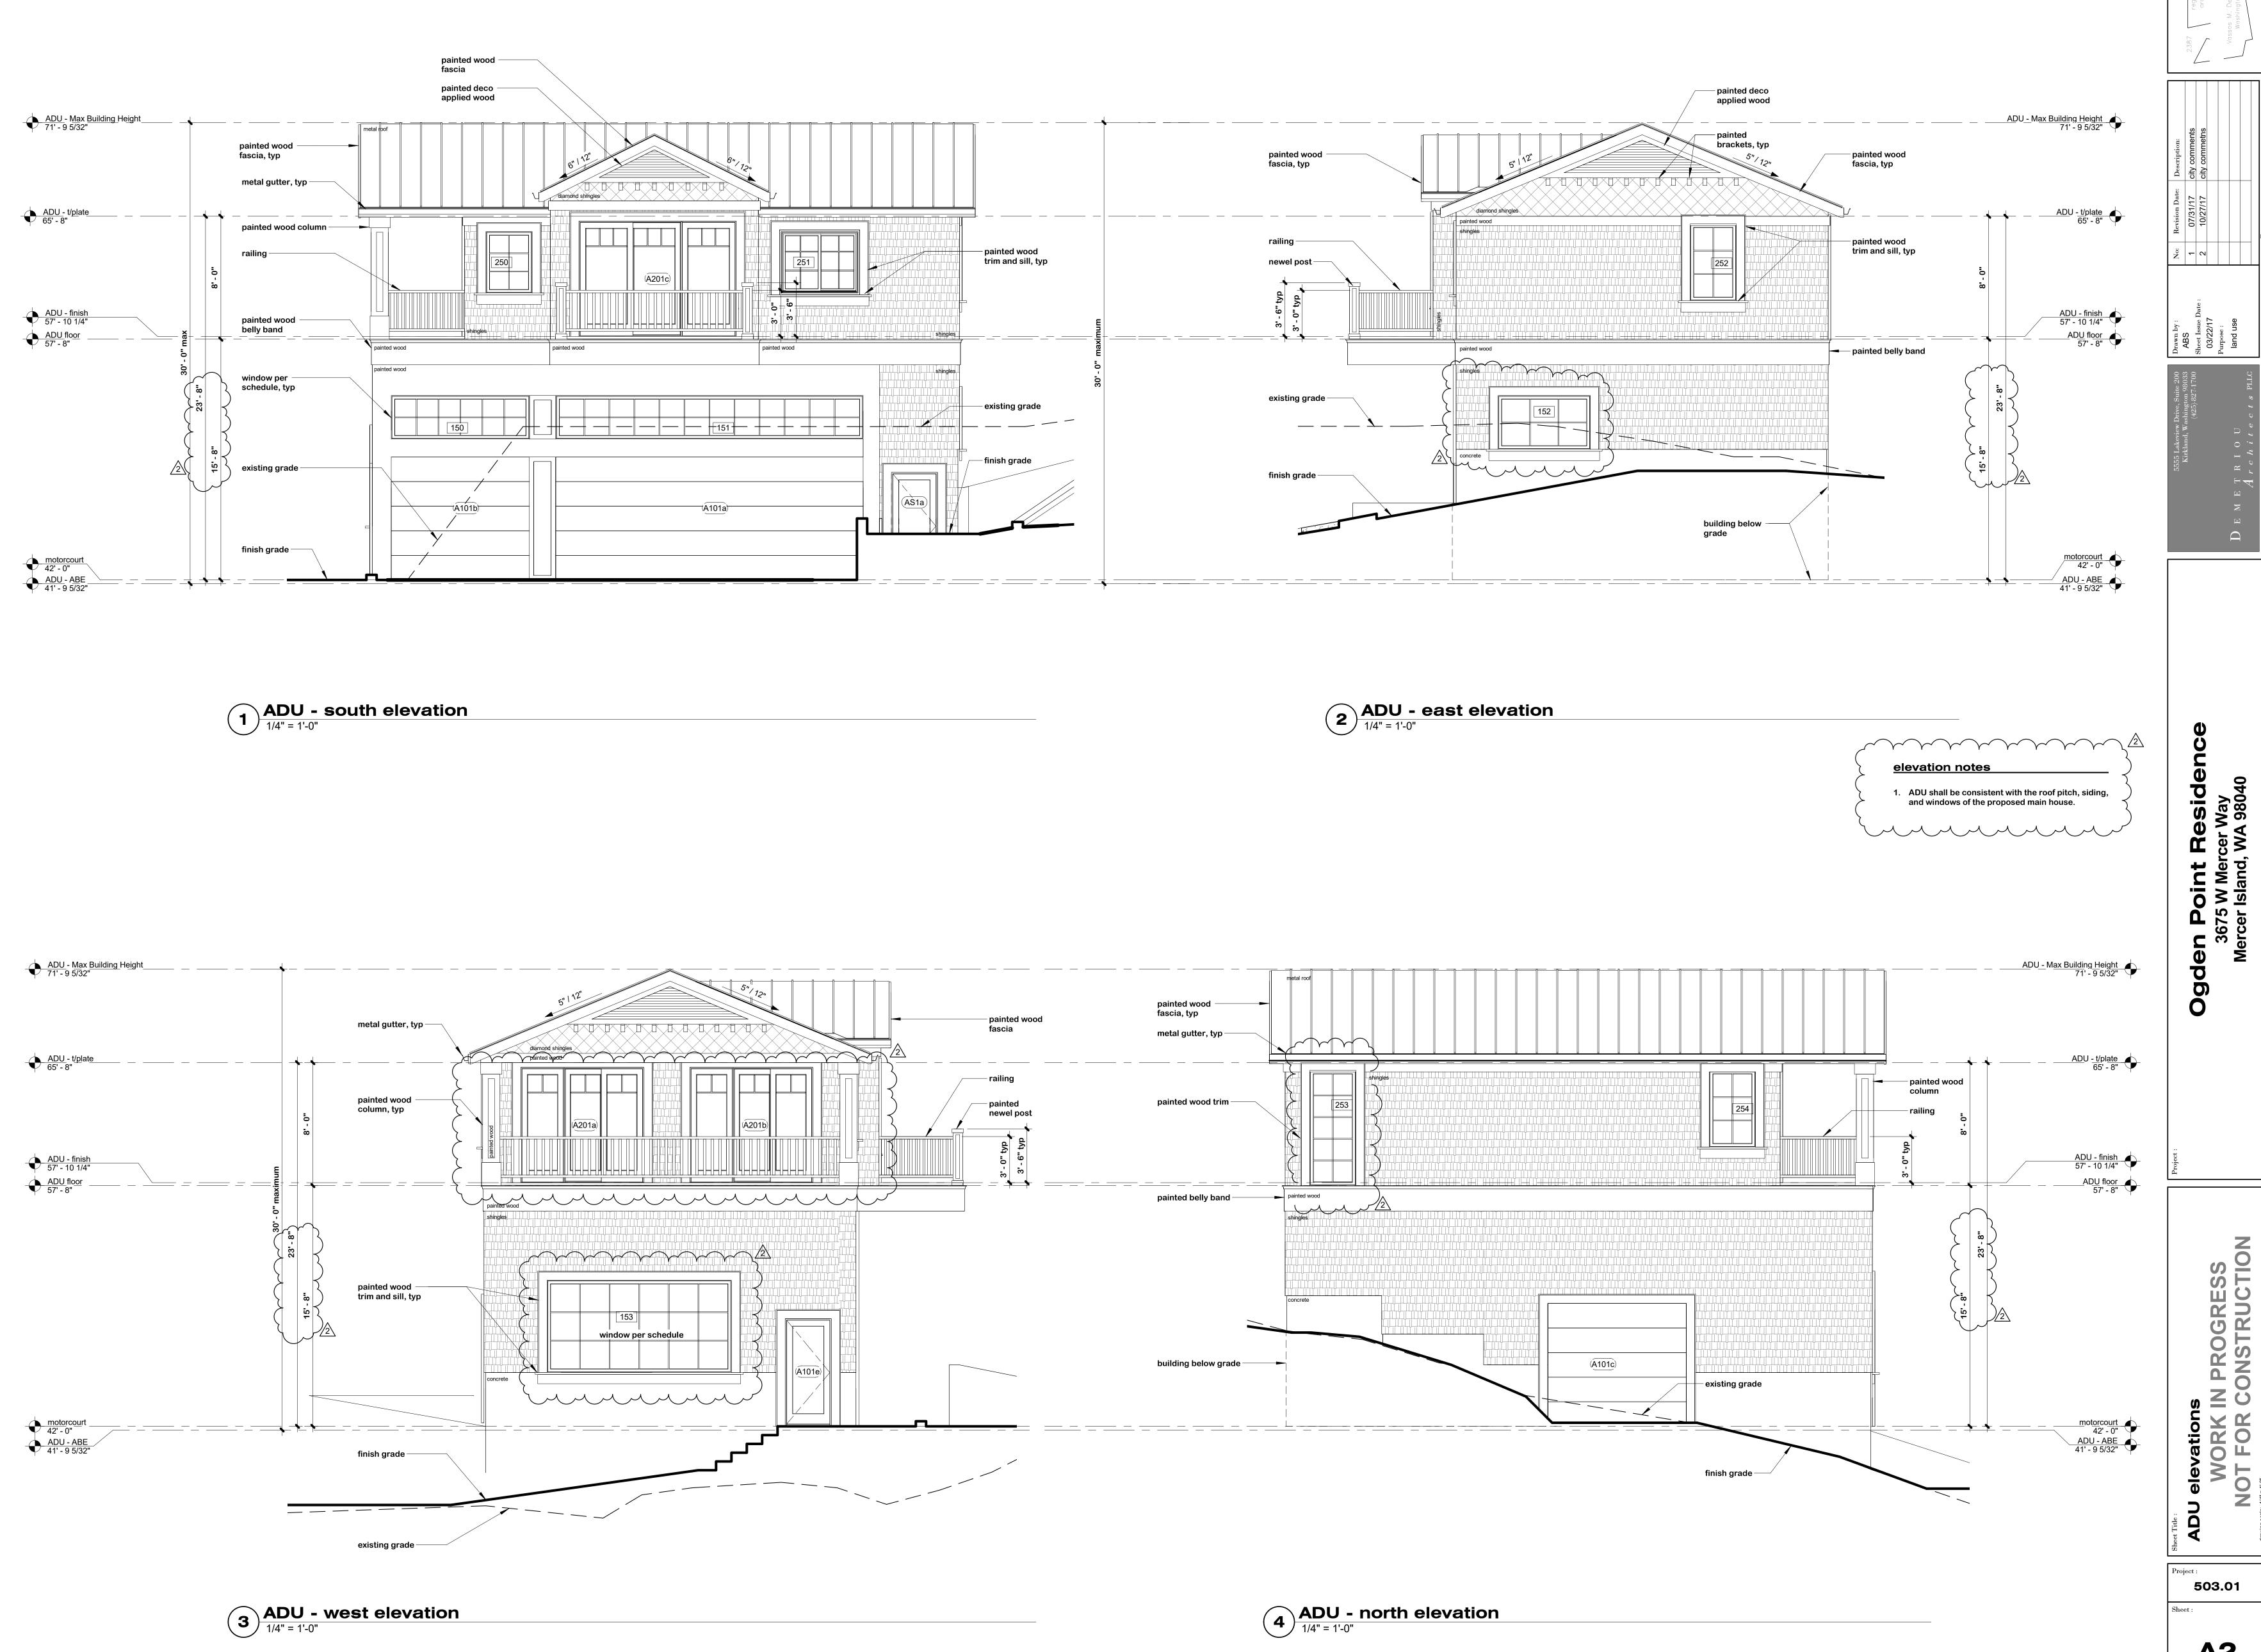
WINTER

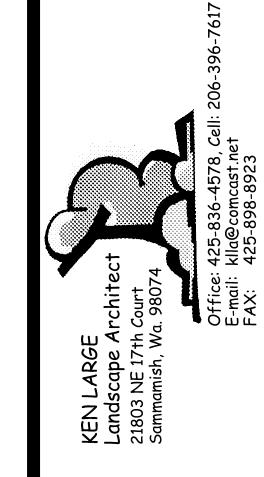5-6' B/B


SHORELINE PLANTING PLAN LOT 3 PERMIT SET

SHEET NUMBER:





**A2** 

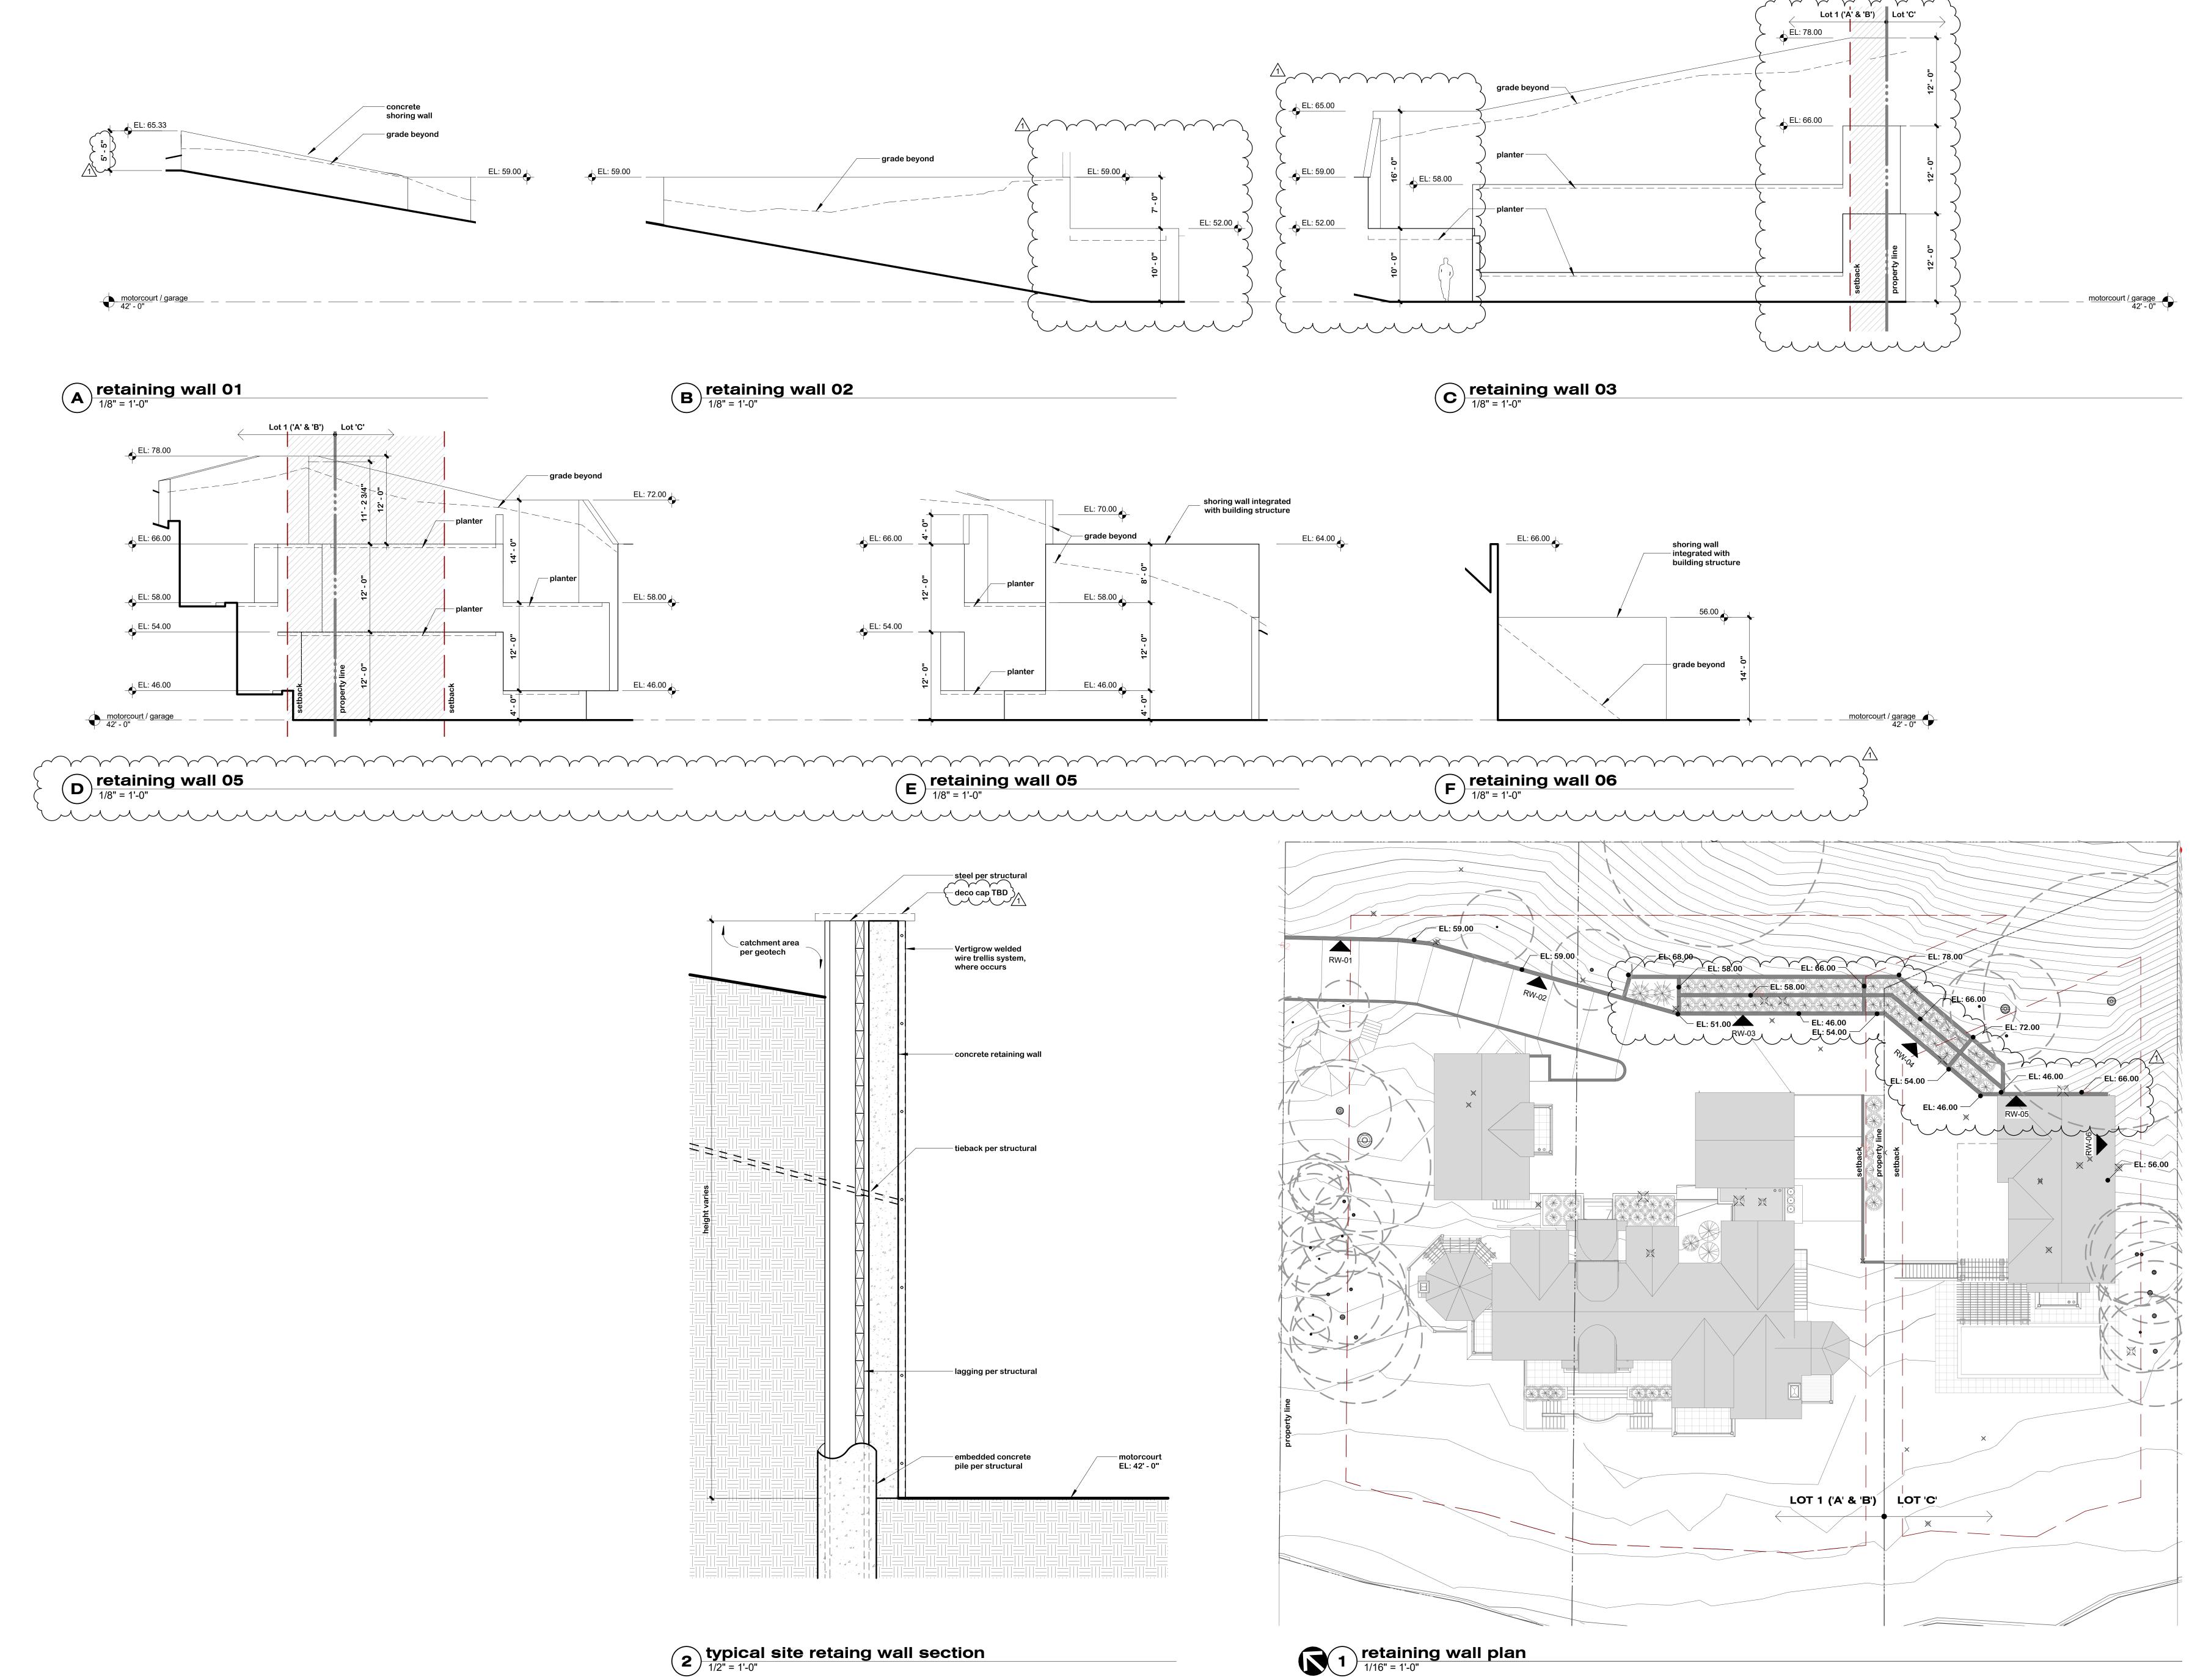

Ogden Point Reside 3675 W Mercer Way Mercer Island, WA 98040

503.01

**A2.3** 

plotted: 10/27/2017 10:11:25 AM